


Building
33 Cup B

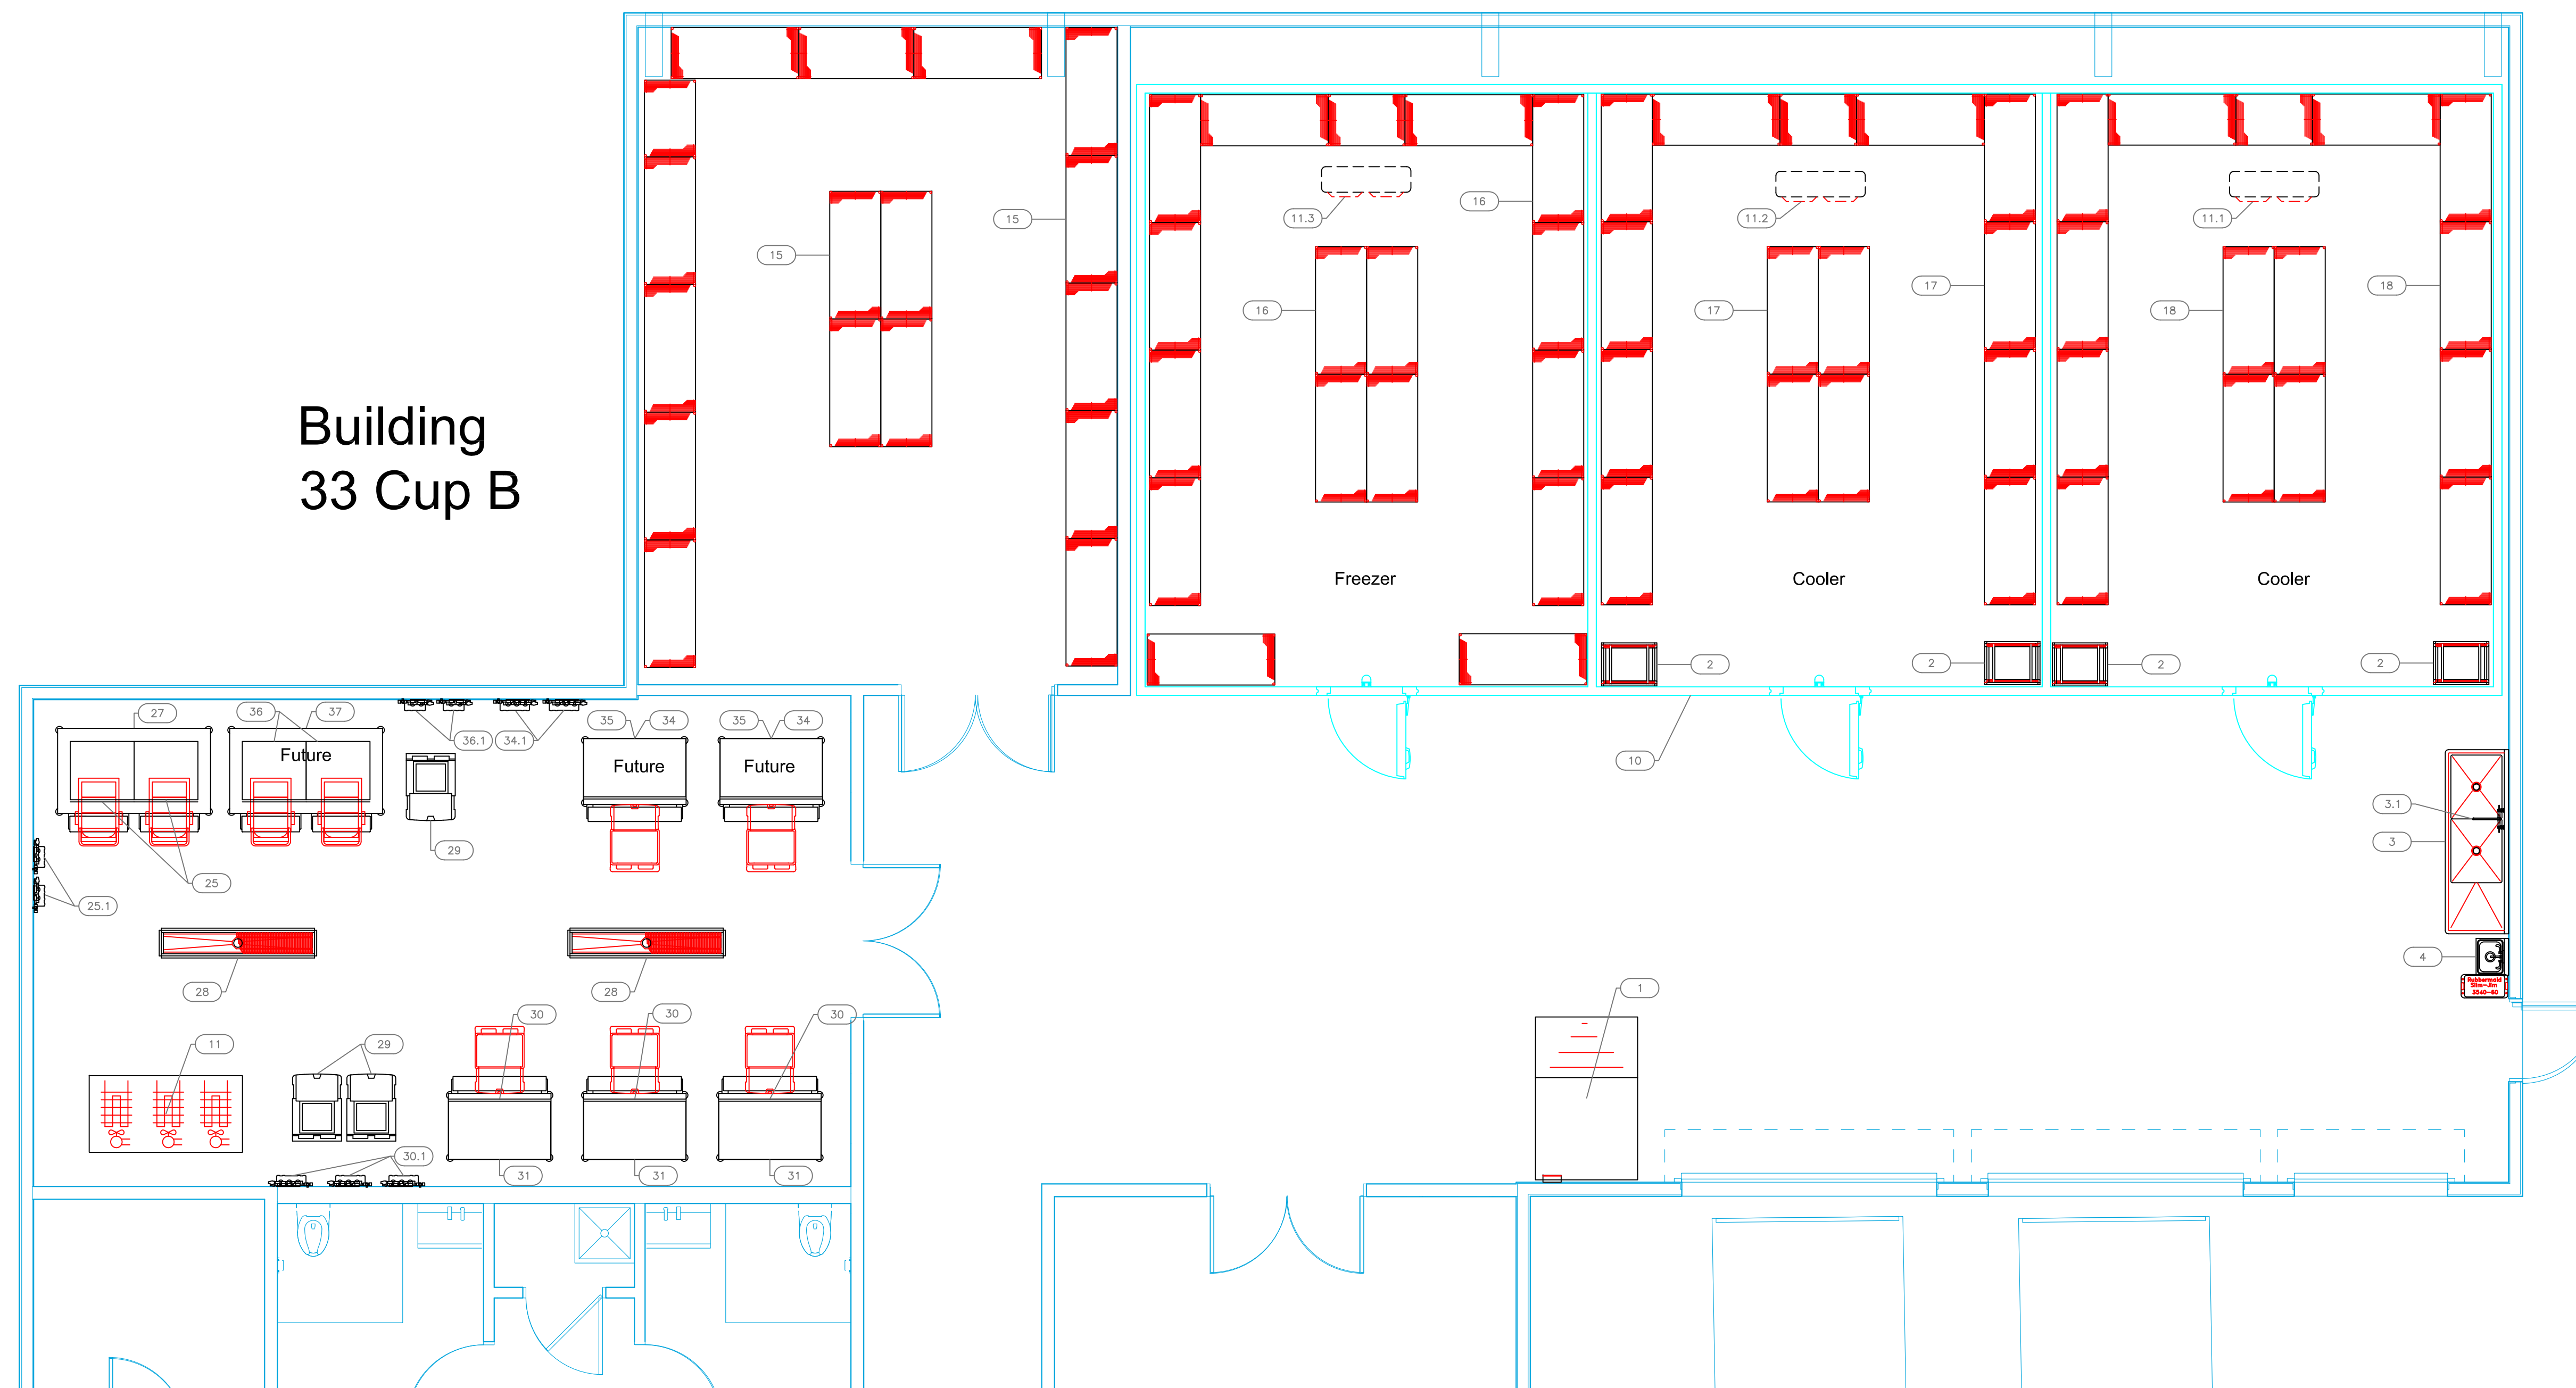

| EQUIPMENT SCHEDULE | | | | | |
|--------------------|---|-------------------|---------------------|----------|-------------------|
| ItemNo | Category | Mfr | Model | Quantity | Equipment Remarks |
| 1 | Scale | Detecto | FH-544F-180 | 1 | |
| 2 | Bun / Sheet Pan Rack | Advance Tabco | PR20-3W | 4 | |
| 3 | Two (2) Compartment Sink | Advance Tabco | FS-2-3024-24R | 1 | |
| 3.1 | Wall / Splash Mount Faucet | Krowne | 14-812L | 1 | |
| 4 | Hand Sink | Advance Tabco | 7-PS-68-1X | 1 | |
| 5-9 | Spare Number | | | | |
| 10 | Walk-in Cooler/Cooler/Freezer | Arctic Industries | WALKIN-161852 V.004 | 1 | |
| 11 | Refrigeration System, Remote | Cooltec | WIPS-6 | 1 | |
| 11.1 | Evaporator Coil | Cooltec | EVAP COOLER | 1 | |
| 11.2 | Evaporator Coil | Cooltec | EVAP COOLER | 1 | |
| 11.3 | Evaporator Coil | Cooltec | ECAP FREEZER | 1 | |
| 12-14 | Spare Number | | | | |
| 15 | Wire Shelving Unit | NEXEL | 24606N | 16 | |
| 16 | Wire Shelving Unit | NEXEL | 24606N | 16 | |
| 17 | Wire Shelving Unit | NEXEL | 24606N | 14 | |
| 18 | Wire Shelving Unit | NEXEL | 24606N | 14 | |
| 19-24 | Spare Number | | | | |
| 25 | Ice Flaker | Hoshizaki | F-1501MWJ | 2 | |
| 25.1 | Water Filtration System, for Ice Machines | Everpure | EV932402 | 2 | |
| 26 | Spare Number | | | | |
| 27 | Ice Bin for Ice Machines | Follett | ITS1350SG-60 | 1 | |
| 28 | Floor Trough | Emjac | F34510-28 | 2 | |
| 29 | Ice Bin / Ice Caddy , Mobile | Cambro | ICS125LB110 | 3 | |
| 30 | Ice Maker, Cube-Style | Hoshizaki | KM-1900SWJ3 | 3 | |
| 30.1 | Water Filtration System, for Ice Machines | Everpure | EV932503 | 3 | |
| 31 | Ice Bin for Ice Machines | Follett | DEV1300SG-48-ICS125 | 3 | |
| 34 | Ice Maker, Cube-Style | Hoshizaki | KM-1900SWJ3 | 2 | Future |
| 34.1 | Water Filtration System, for Ice Machines | Everpure | EV932503 | 2 | Future |
| 35 | Ice Bin for Ice Machines | Follett | DEV1300SG-48-ICS125 | 2 | Future |
| 36 | Ice Flaker | Hoshizaki | F-1501MWJ | 2 | Future |
| 36.1 | Water Filtration System, for Ice Machines | Everpure | EV932402 | 2 | Future |
| 37 | Ice Bin for Ice Machines | Follett | DEV2100SG-72-75 | 1 | Future |

EQUIPMENT
LAYOUT

All Dimensions to be verified on the job site.
Actual locations for floor drains, and any ventilating
equipment to be determined by Engineer.
Mechanical, Plumbing & Electrical to be checked and verified
by Customers MEP Engineer.
Remote Condensing Units to be located by Architect.
Exhaust & Supply fans to be located by Architect.

Baha Mar Bay
Building 33 (Cup B)
Nassau Bahamas



INTERNATIONAL INC.

2055 W 73rd Street, Miami, FL 33016
Ph: (305)826-8696 Fax: (305)826-9131

| | | |
|-----|---|---------|
| 1 | Preliminary Layout | 8-4-20 |
| 2 | Added Equipment MEP Info., adjusted Walk-in | 8-10-20 |
| 3 | Adjusted Floor Troughs | 8-11-20 |
| 4 | Adjusted Walk-in Cooler by 24" depth for columns | 8-24-20 |
| No. | Revision/Issue | Date |

Date
August 24, 2020
Drawn By
Dayne Gauntlett
Scale
1/4" = 1'0"

Sheet
FS-1.0

Baha Mar Bay
Building 33 (Cup B)
Nassau Bahamas




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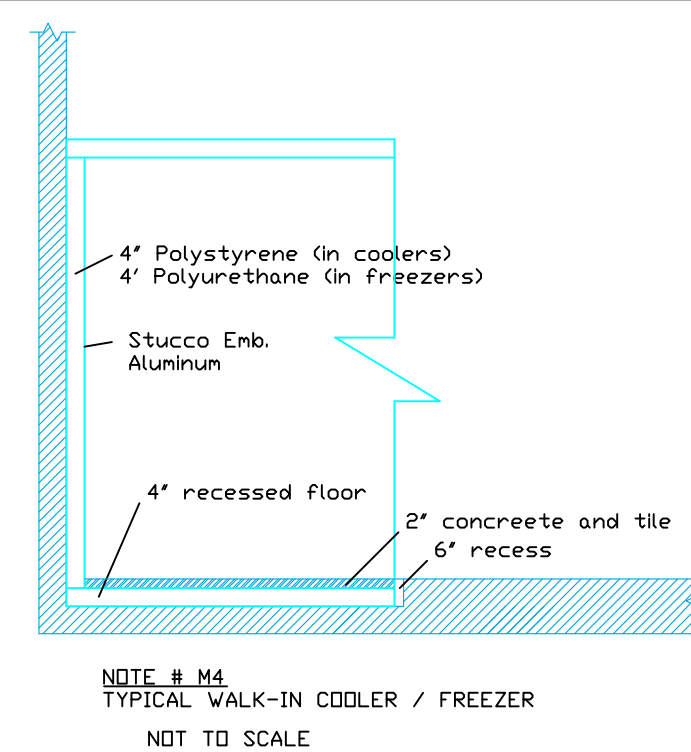
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LEGEND – MECHANICAL

- EXHAUST DUCT COLLAR
- SUPPLY DUCT COLLAR
- INWALL BACKING FOR WALL SHELVES
- RECESSED FLOOR
- RAISED EQUIPMENT PAD



NOTE # M4
TYPICAL WALK-IN COOLER / FREEZER
NOT TO SCALE

Equipment
MECHANICAL
Service Requirements

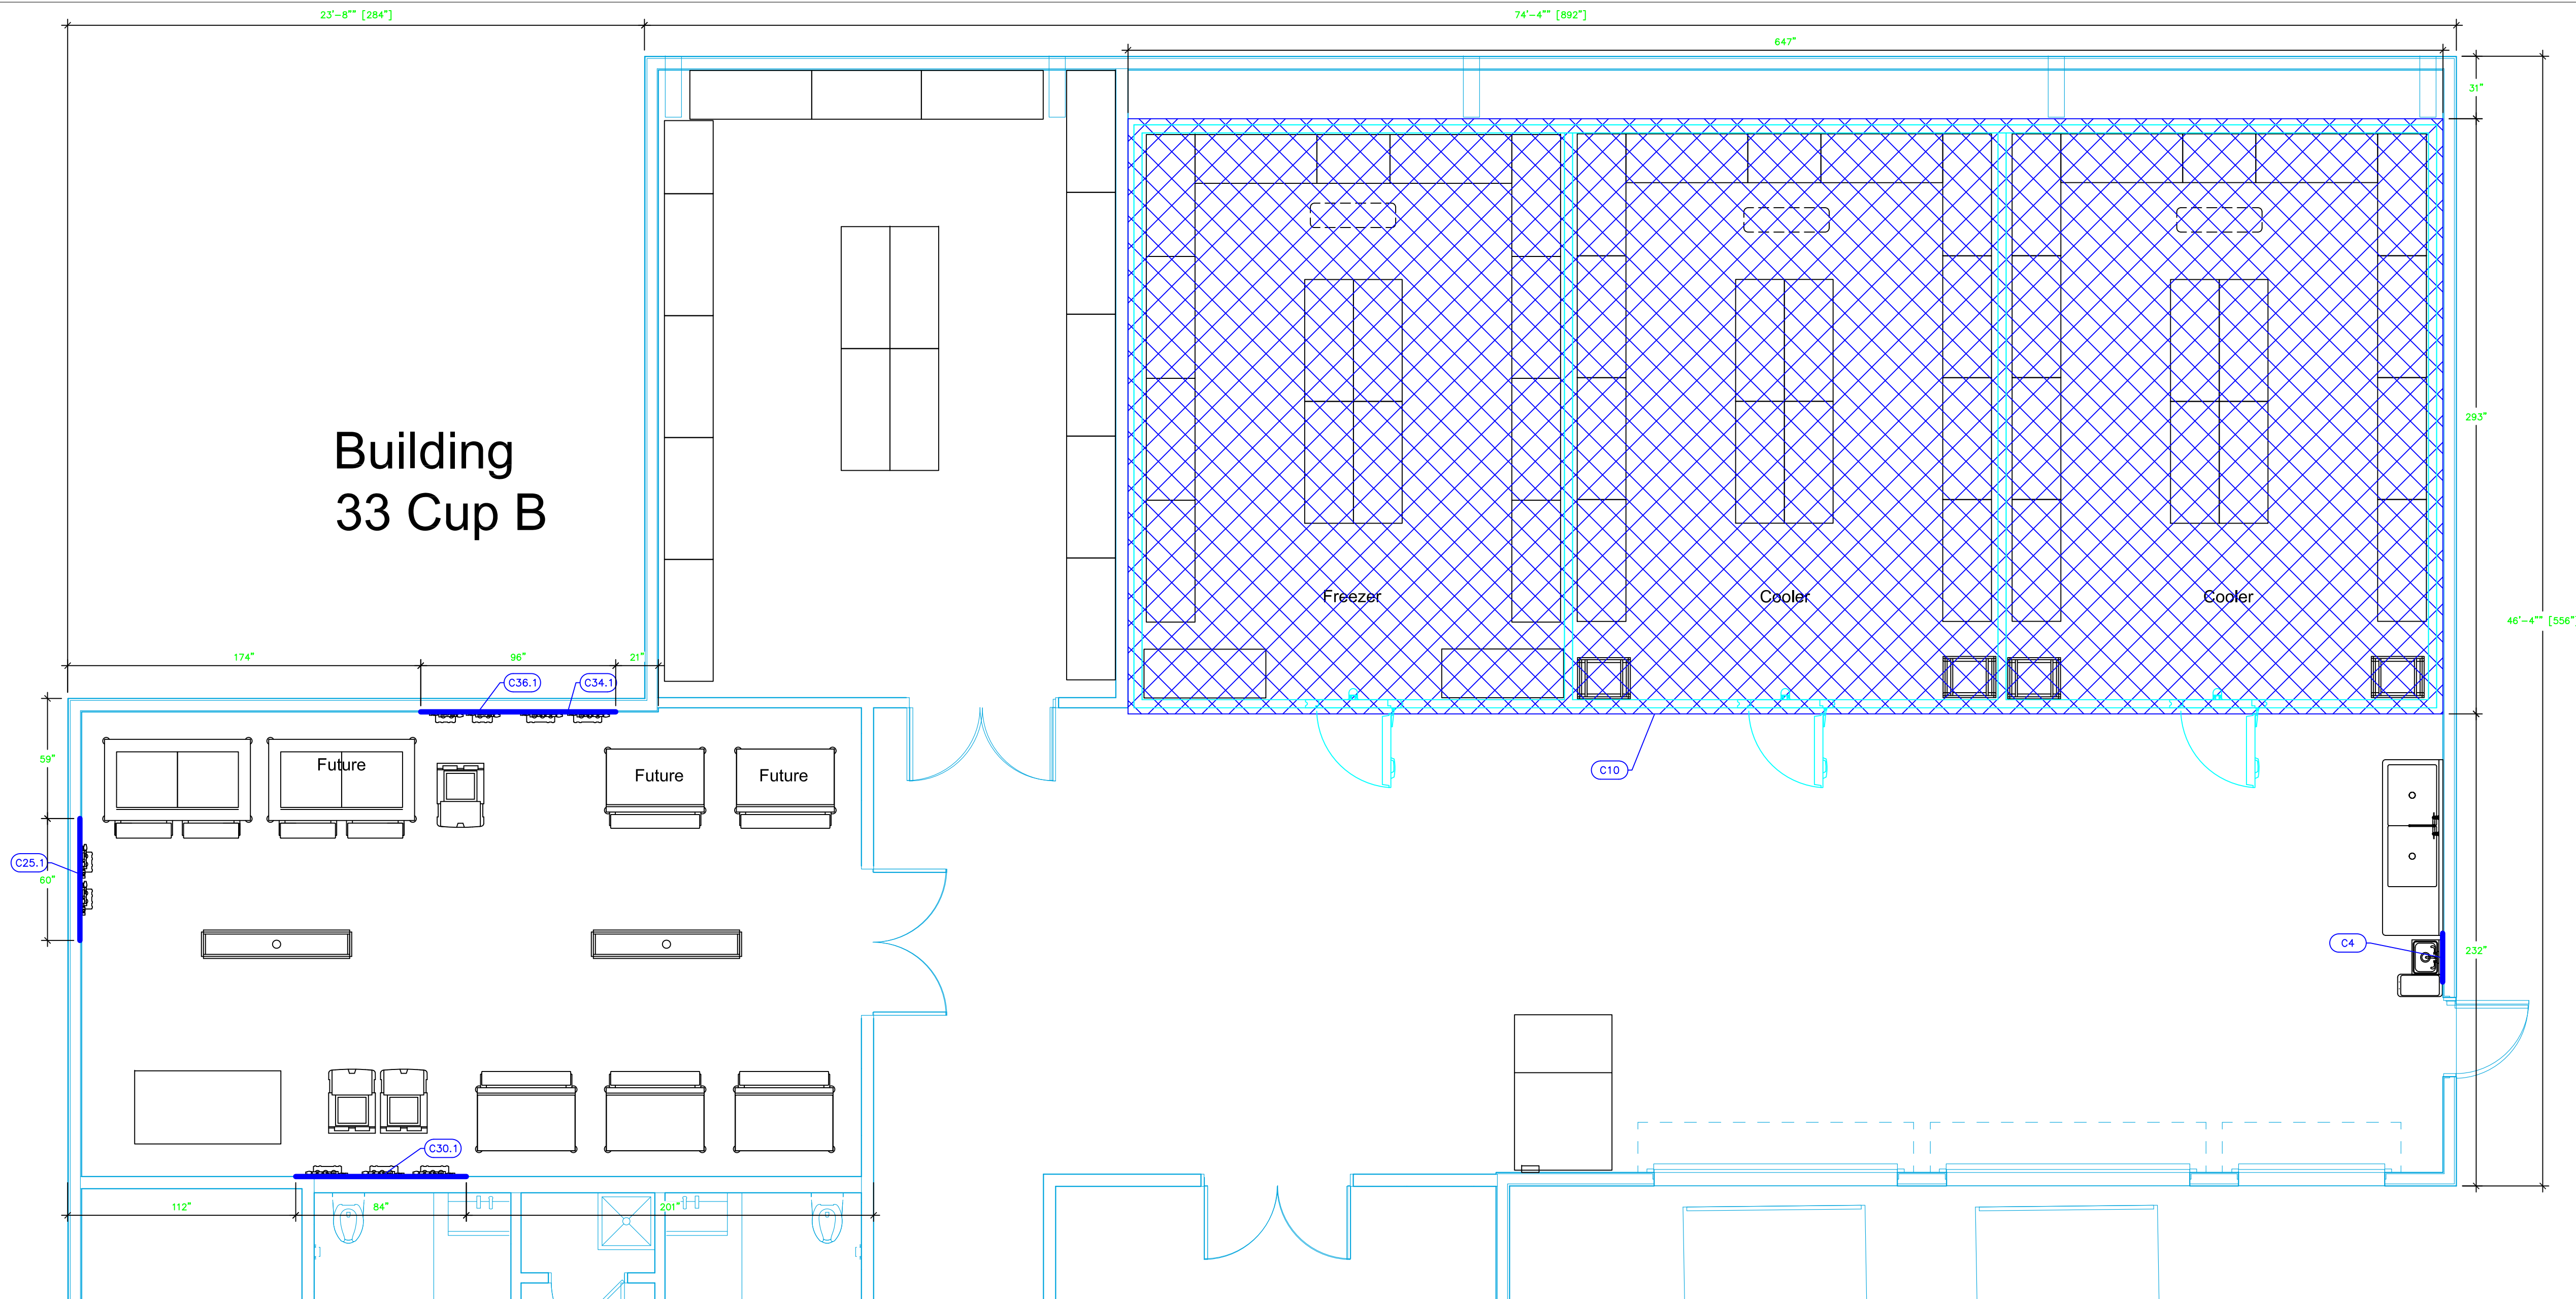All Dimensions to be verified on the job site.
Actual locations for floor drains, and any ventilating
equipment to be determined by Engineer.
Mechanical, Plumbing & Electrical to be checked and verified
by Customers MEP Engineer.
Remote Condensing Units to be located by Architect.
Exhaust & Supply fans to be located by Architect.

NOTE # M5
ALL NATIONAL, STATE, AND LOCAL
CODES SHALL APPLY

NOTE # M6
ARCHITECT OR ENGINEER TO SIZE
AND LOCATE, CONTRACTOR TO
PROVIDE ALL OPENINGS FOR
DUCTS, PLUMBING LINES,
ELECTRICAL LINES, AND
REFRIGERATION LINES, AS
REQUIRED BY EQUIPMENT.

NOTE # M7
SUPPLY FANS TO BE LOCATED A
MINIMUM OF 10' FROM EXHAUST
FANS.

NOTE # M8
SHOP DRAWING WILL BE
PROVIDED BY MANUFACTURER FOR
HOOD, EXHAUST FANS, & SUPPLY
FANS, ONCE ORDER IS PLACED
WITH.

NOTE # M9
GENERAL CONTRACTOR TO
PROVIDE 2" PLYWOOD WALL
BACKING FROM 48" TO 78" AFF
FOR ALL WALL MOUNTED
EQUIPMENT.


NOTE # M10
CEILING HEIGHTS TO BE
VERIFIED FOR SUFFICIENT
CLEARANCE FOR EQUIPMENT.

NOTE # M11
REFRIGERATION CONTRACTOR TO
HANG EVAPORATORS FOR
WALK-IN, RUN & CHARGE LINES
BETWEEN EVAP. & CONDENSING
UNIT.

Mechanical Schedule

| ITEM NO. | QTY | DISCRPTION | EXHAUST (L X W) | EXHAUST (CFM) | Makeup Vent Width | SUPPLY (CFM) | Ventilation Remarks |
|----------|-----|---|-----------------|---------------|-------------------|--------------|----------------------------|
| 4 | 1 | Hand Sink | | | | | Wall Backing See Note M9 |
| 10 | 1 | Walk-in Cooler/Cooler/Freezer | | | | | Recessed Floor See Note M4 |
| 25.1 | 2 | Water Filtration System, for Ice Machines | | | | | Wall Backing See Note M9 |
| 30.1 | 3 | Water Filtration System, for Ice Machines | | | | | Wall Backing See Note M9 |
| 34.1 | 2 | Water Filtration System, for Ice Machines | | | | | Wall Backing See Note M9 |
| 36.1 | 2 | Water Filtration System, for Ice Machines | | | | | Wall Backing See Note M9 |

Building
33 Cup B

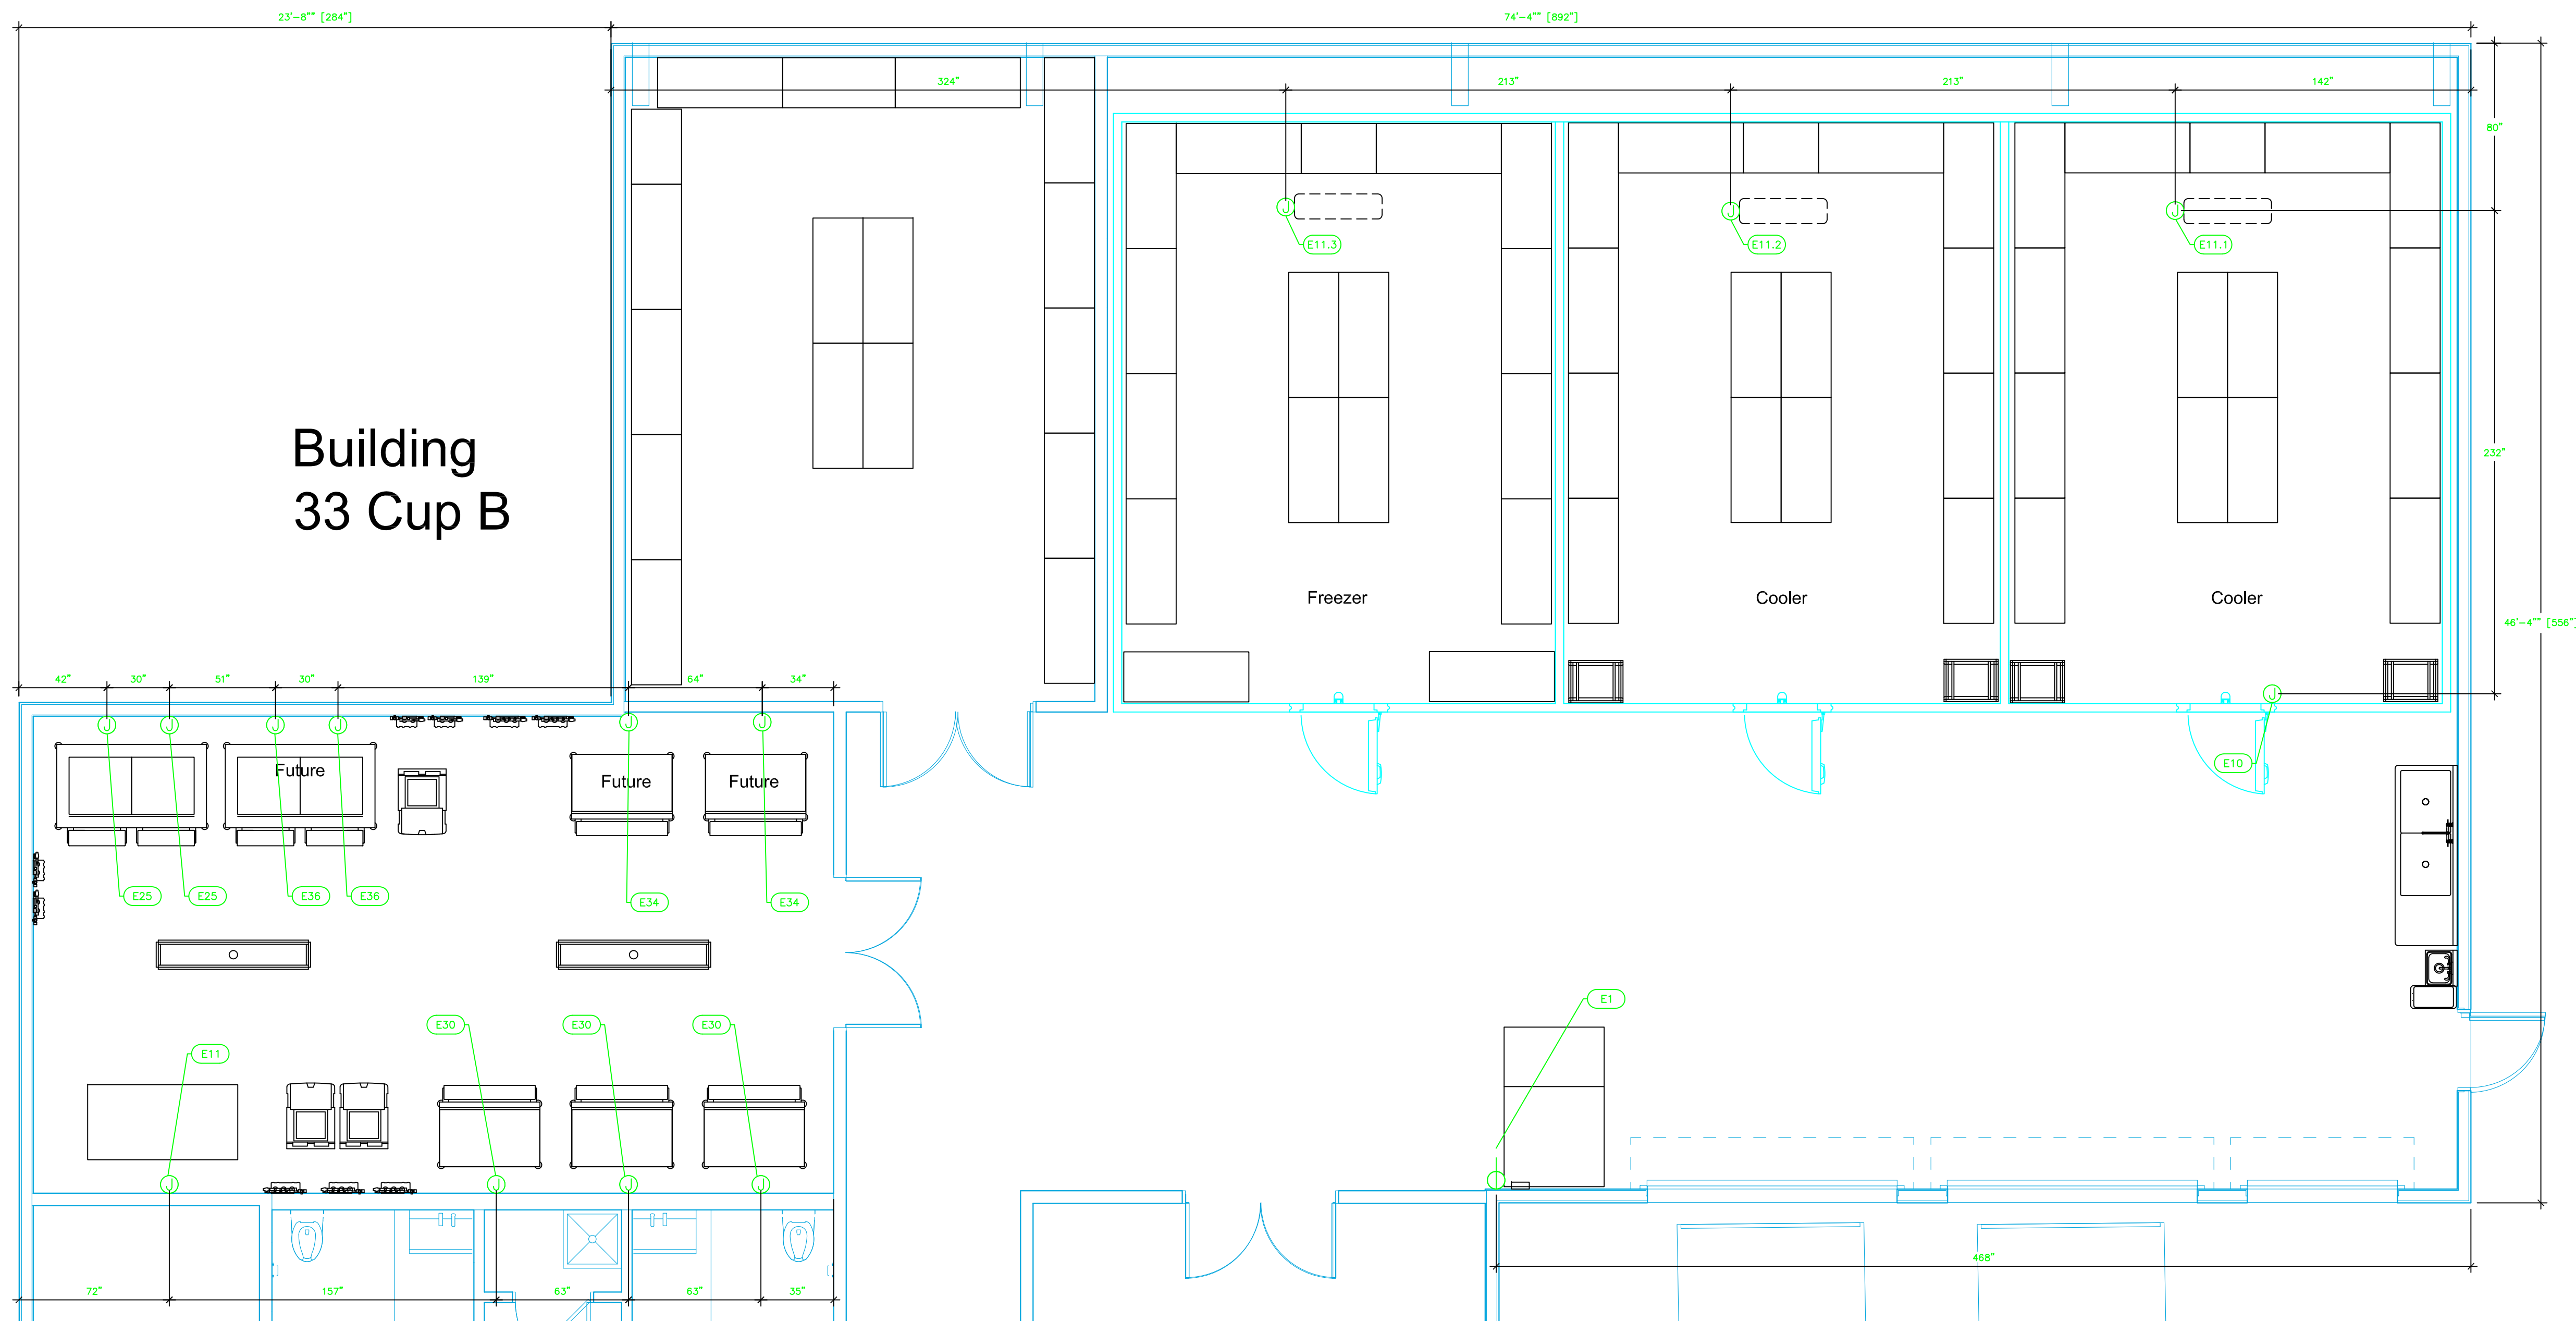

| ELECTRICAL SCHEDULE | | | | | | | | | | | |
|---------------------|-------------------------------|---------|-------|-------|------|----|------|----------------|--------------|----------|-------------------------------|
| ItemNo | Category | Voltage | Cycle | Phase | Amps | Hp | NEMA | ConnectionType | Rough-In AFF | Quantity | Electrical Remarks |
| 1 | Scale | 115 | 60 | 1 | 15 | | | Simplex | 18" | 1 | |
| 10 | Walk-in Cooler/Cooler/Freezer | 115 | 60 | 1 | 15 | | | J-Box | 108" | 1 | Elec for Lights in Walk-In |
| 11 | Refrigeration System, Remote | 208 | 60 | 3 | 57.1 | | | J-Box | 108" | 1 | See Shop Drawings for Details |
| 11.1 | Evaporator Coil | 115 | 60 | 1 | 4.5 | | | J-Box | 108" | 1 | See Shop Drawings for Details |
| 11.2 | Evaporator Coil | 115 | 60 | 1 | 4.5 | | | J-Box | 108" | 1 | See Shop Drawings for Details |
| 11.3 | Evaporator Coil | 208 | 60 | 1 | 32.4 | | | J-Box | 108" | 1 | See Shop Drawings for Details |
| 25 | Ice Flaker | 208-230 | 60 | 1 | 15.4 | | | J-Box | 84" | 2 | |
| 30 | Ice Maker, Cube-Style | 208-230 | 60 | 3 | 8.9 | | | J-Box | 84" | 3 | |
| 34 | Ice Maker, Cube-Style | 208-230 | 60 | 3 | 8.9 | | | J-Box | 84" | 2 | |
| 36 | Ice Flaker | 208-230 | 60 | 1 | 15.4 | | | J-Box | 84" | 2 | |

LEGEND -- ELECTRICAL CONNECTIONS

- DUPLEX RECEPT., 15-AMP, 120-VOLT, GROUND TYPE, HORIZONTAL MOUNT
- SIMPLEX RECEPT., 120-VOLT, GROUND TYPE, HORIZONTAL MOUNT
- SPECIAL PURPOSE OUTLET, GROUND TYPE, HORIZONTAL MOUNT
- JUNCTION BOX, DIRECT CONNECTION
- DISCONNECT SWITCH, DIRECT CONNECTION
- FLOOR/CEILING RECEPTACLE AS INDICATED
- (2) Telephone + (2) Data
- FIELD CONNECTIONS
- HARD WIRE CONNECTION POINT AT MACHINE

NOTE # E2:
ALL NATIONAL, STATE, AND LOCAL CODES SHALL APPLY

NOTE # E3:
ALL ELECTRICAL CONNECTIONS AND HARDWARE REQUIRED TO BE PROVIDED BY ELECTRICAL CONTRACTOR


NOTE # E4:
ALL JUNCTION BOXES, OUTLETS, ETC. TO BE LOCATED SO AS TO NOT INTERFERE WITH EQUIPMENT

NOTE # E5:
ALL RELAYS, CONTRACTORS, STARTERS, AND SWITCHES REQUIRED FOR EXHAUST & SUPPLY FANS TO BE PROVIDED BY ELECTRICAL CONTRACTOR UNLESS SPECIFIED

NOTE # E6:
ELECTRICAL CONTRACTOR TO INTERCONNECT DISHMACHINE TO EXHAUST FAN FOR DISHMACHINE SO THAT THE FAN RUNS WHEN THE DISHMACHINE IS IN OPERATION.

NOTE # E7:
ELECTRICAL CONTRACTOR TO INSTALL TABLE LIMIT SWITCH TO END OF CLEAN DISHTABLE TO THAT MACHINE STOPS WHEN SWITCH IS DEPRESSED.

NOTE # E8:
ELECTRICAL CONTRACTOR TO CONNECT DRAIN LINE HEATER, PAN HEATER AND DOOR HEATER FOR WALK-IN FREEZER.

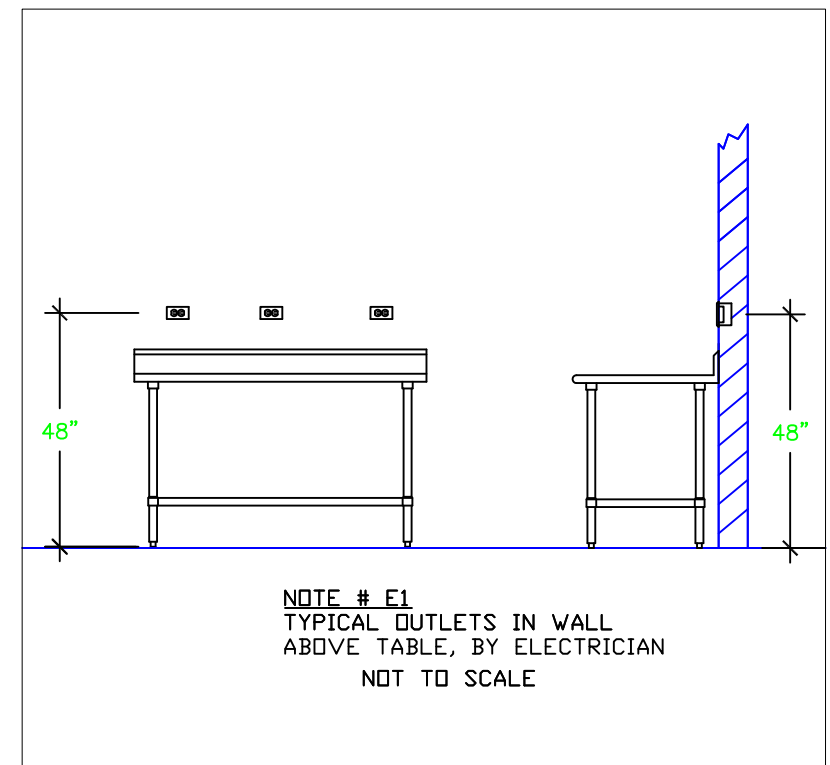

Equipment
ELECTRICAL
Service Requirements

All Dimensions to be verified on the job site.
Actual locations for floor drains, and any ventilating equipment to be determined by Engineer.
Mechanical, Plumbing & Electrical to be checked and verified by Customers MEP Engineer.
Remote Condensing Units to be located by Architect.
Exhaust & Supply fans to be located by Architect.

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Nassau Bahamas



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| No. | Revision/Issue | Date |

Date

August 24, 2020

Drawn By

Dayne Gauntlett


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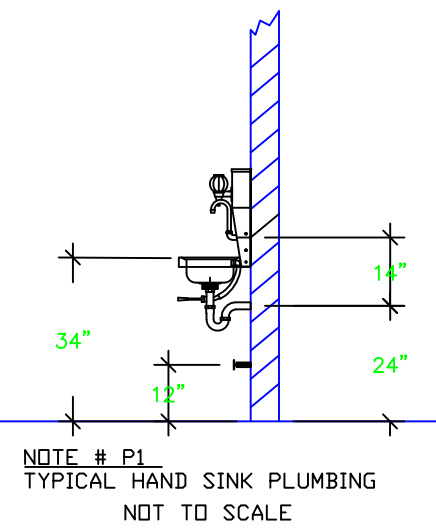
Building
33 Cup B



| PLUMBING SCHEDULE | | | | | | | | | | | |
|-------------------|---|-----------------------|----------------------|--------------|-------------------------|------------------------|---------------------------|-----------------|-------------|-----|---------------------|
| ITEM NO. | DESCRIPTION | COLD WATER SIZE | HOT WATER SIZE | H&C Rough-In | DIRECT WASTE SIZE | DIRECT WASTE AFF | INDIRECT WASTE SIZE | GAS SIZE(IN) | GAS MBTU | QTY | PLUMBING REMARKS |
| 3 | Two (2) Compartment Sink | | | | | | (2) 1-1/2" | | | 1 | Waste to Floor Sink |
| 3.1 | Wall / Splash Mount Faucet | 1/2" | 1/2" | 12" | | | | | | 1 | |
| 4 | Hand Sink | 1/2" | 1/2" | 12" | 1-1/2" | 20" | | | | 1 | |
| 11.1 | Evaporator Coil | | | | | | 1" | | | 1 | Condensate to FFD |
| 11.2 | Evaporator Coil | | | | | | 1" | | | 1 | Condensate to FFD |
| 11.3 | Evaporator Coil | | | | | | 1" | | | 1 | Condensate to FFD |
| 25 | Ice Flaker | 1/2" | | n/a | | | 3/4" | | | 2 | Water from Filter |
| 25.1 | Water Filtration System, for Ice Machines | 3/4" | | 36" | | | | | | 2 | Water to Filter |
| 27 | Ice Bin for Ice Machines | | | | | | 1" | | | 1 | Waste to Floor Sink |
| 28 | Floor Trough | | | | 4" | Floor | | | | 2 | |
| 30 | Ice Maker, Cube-Style | 1/2" | | n/a | | | 3/4" | | | 3 | Water from Filter |
| 30.1 | Water Filtration System, for Ice Machines | 3/4" | | 36" | | | | | | 3 | Water to Filter |
| 31 | Ice Bin for Ice Machines | | | | | | 1" | | | 3 | Waste to Floor Sink |
| 34 | Ice Maker, Cube-Style | 1/2" | | n/a | | | 3/4" | | | 2 | Water from Filter |
| 34.1 | Water Filtration System, for Ice Machines | 3/4" | | 36" | | | | | | 2 | Water to Filter |
| 35 | Ice Bin for Ice Machines | | | | | | 1" | | | 2 | Waste to Floor Sink |
| 36 | Ice Flaker | 1/2" | | n/a | | | 3/4" | | | 2 | Water from Filter |
| 36.1 | Water Filtration System, for Ice Machines | 3/4" | | 36" | | | | | | 2 | Water to Filter |
| 37 | Ice Bin for Ice Machines | | | | | | 1" | | | 1 | Waste to Floor Sink |

LEGEND – PLUMBING CONNECTIONS

- HW–HOT WATER, OR CW–COLD WATER
- GAS
- WASTE, DIRECT–CONNECTED
- WASTE, INDIRECT to Floor Sink, or Floor Drain
- ⊕ FUNNEL FLOOR DRAIN Josam 30000–E3
- ⊕ FLOOR DRAIN Josam 30000–A3
- ⊕ FLOOR SINK Zurn FD–2370–y–PV4–F
- ⊕ FILTERED WATER, at machine.
- ⊕ CHILL WATER In & Out

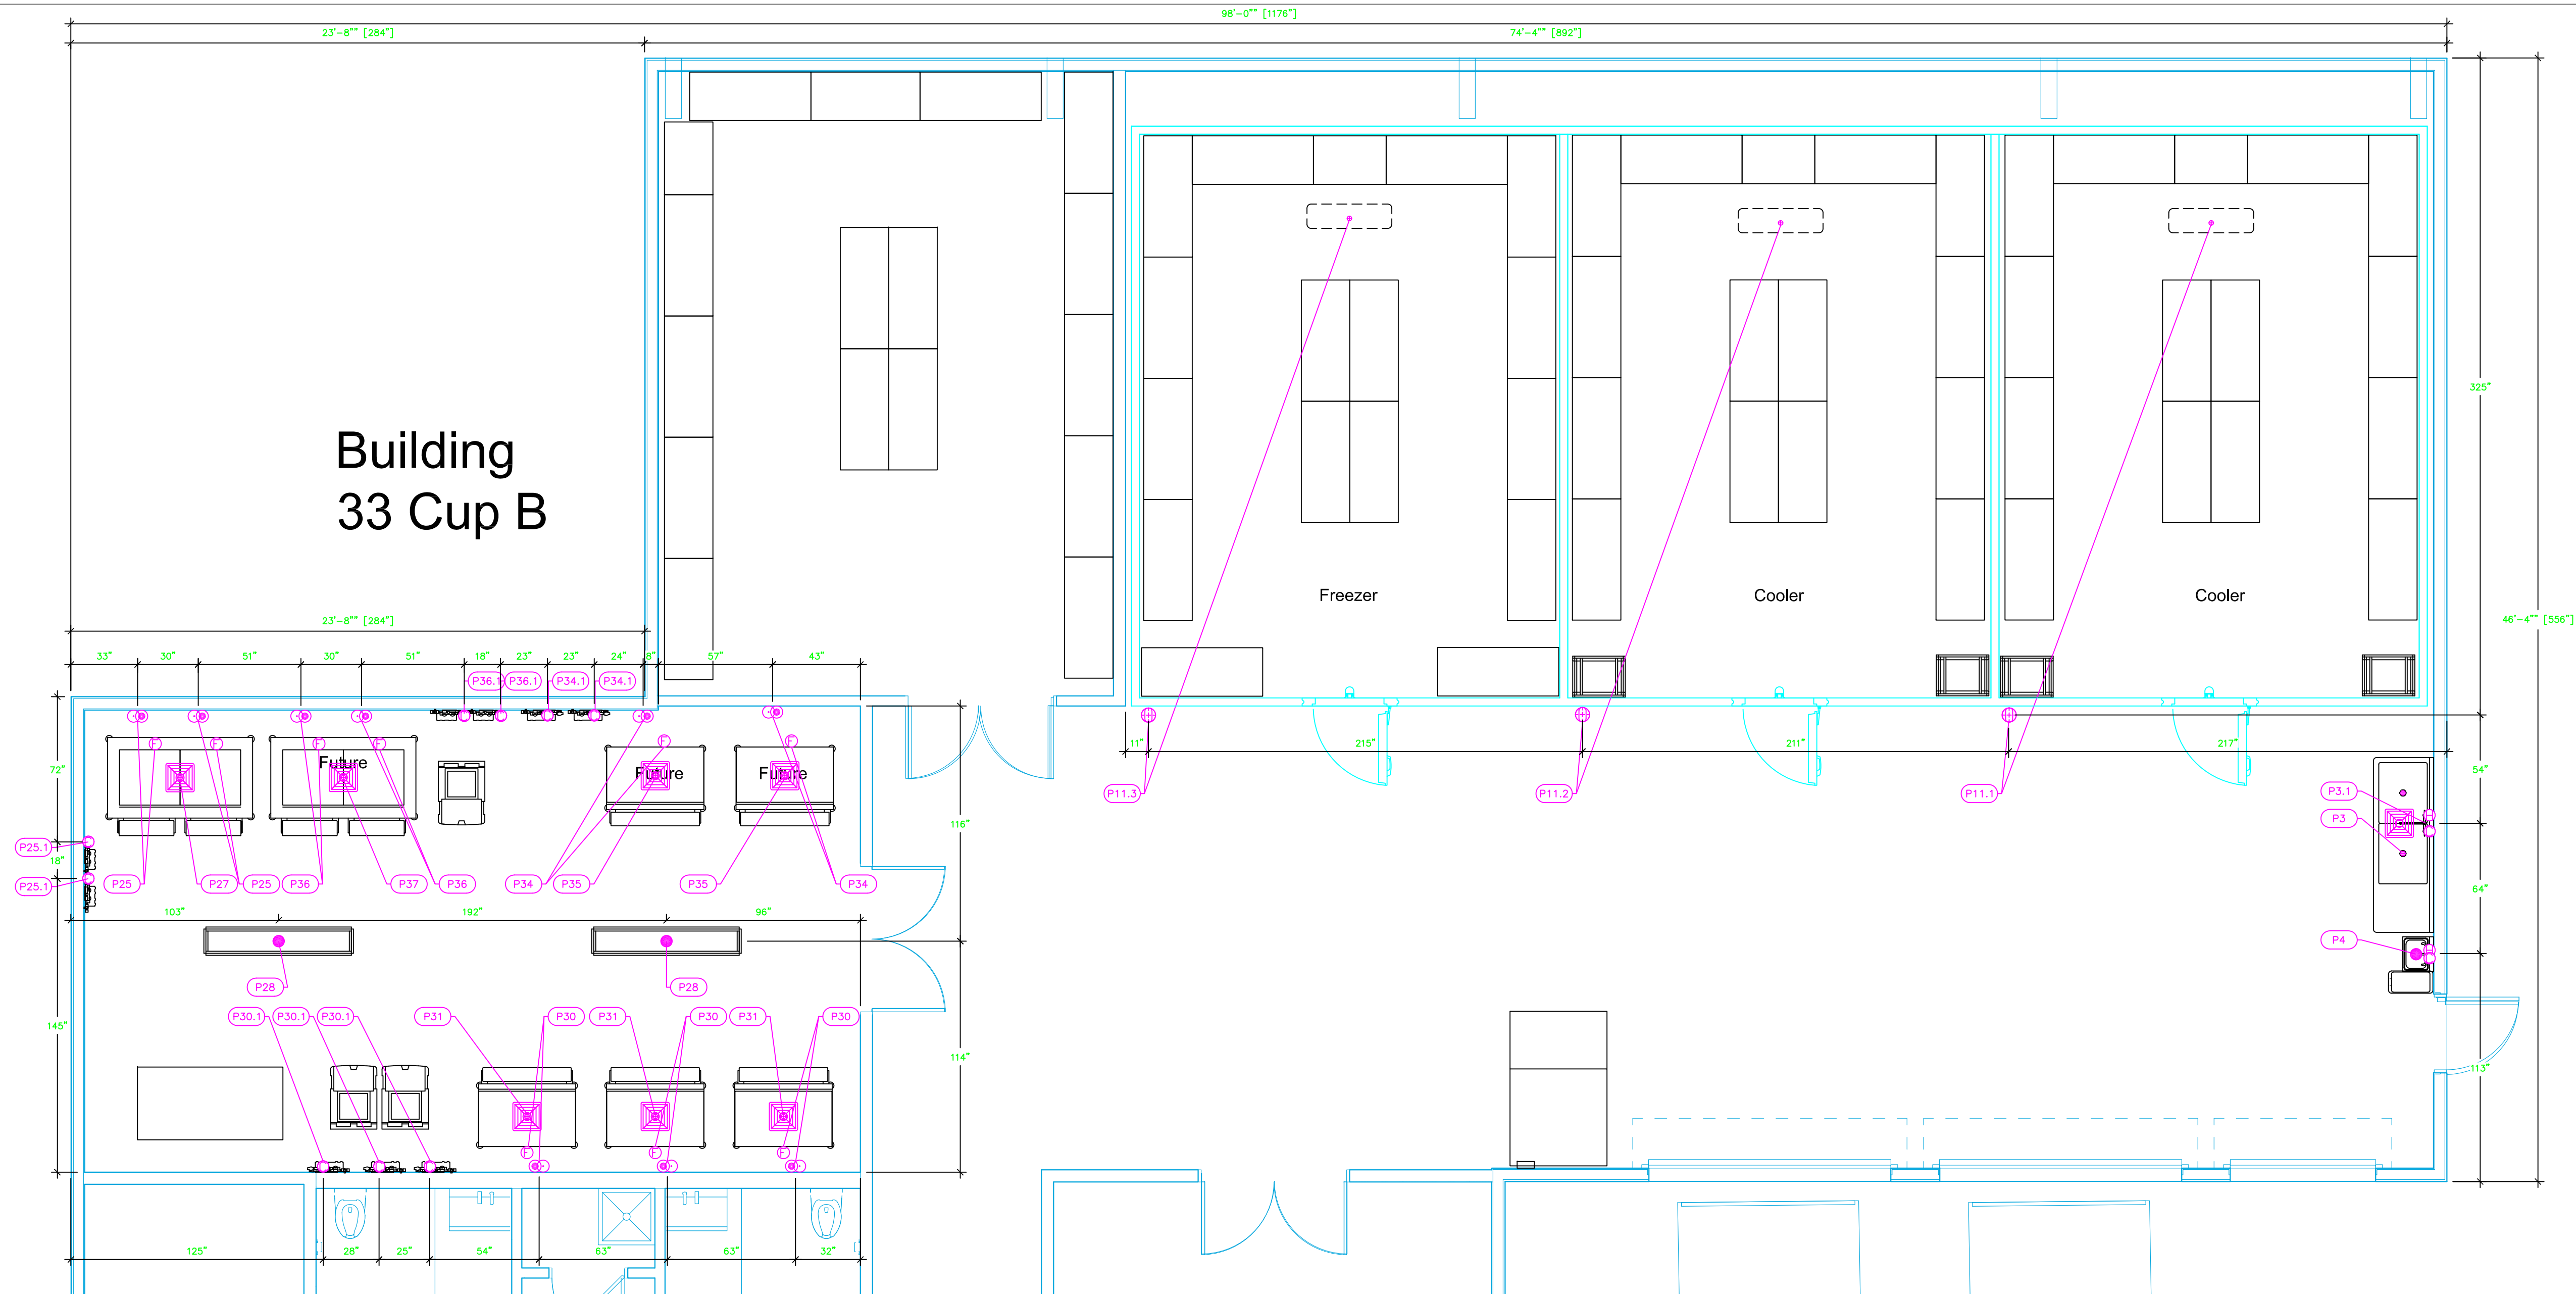

NOTE # P4:
ALL NATIONAL, STATE, AND LOCAL
CODES SHALL APPLY

NOTE # P5:
ALL PLUMBING CONNECTIONS TO
BE EXTENDED AND
INTERCONNECTED TO EQUIPMENT
AND ALL HARDWARE REQUIRED TO
BE PROVIDED BY PLUMBING
CONTRACTOR

NOTE # P6:
PLUMBING CONTRACTOR TO VERIFY
THAT ALL EQUIPMENT IS
INSTALLED WITH THE
APPROPRIATE GAS PRESSURE AND
REGULATORS

NOTE # P7:
ALL WASTE LINES AND
CONDENSATE LINES TO BE EXTEND
FROM EQUIPMENT TO FLOOR
DRAINS BY PLUMBING CONTRACTOR.

Equipment
PLUMBING
Service Requirements

All Dimensions to be verified on the job site.
Actual locations for floor drains, and any ventilating
equipment to be determined by Engineer.
Mechanical, Plumbing & Electrical to be checked and verified
by Customers MEP Engineer.
Remote Condensing Units to be located by Architect.
Exhaust & Supply fans to be located by Architect.

Baha Mar Bay
Building 33 (Cup B)
Nassau Bahamas




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| | | |
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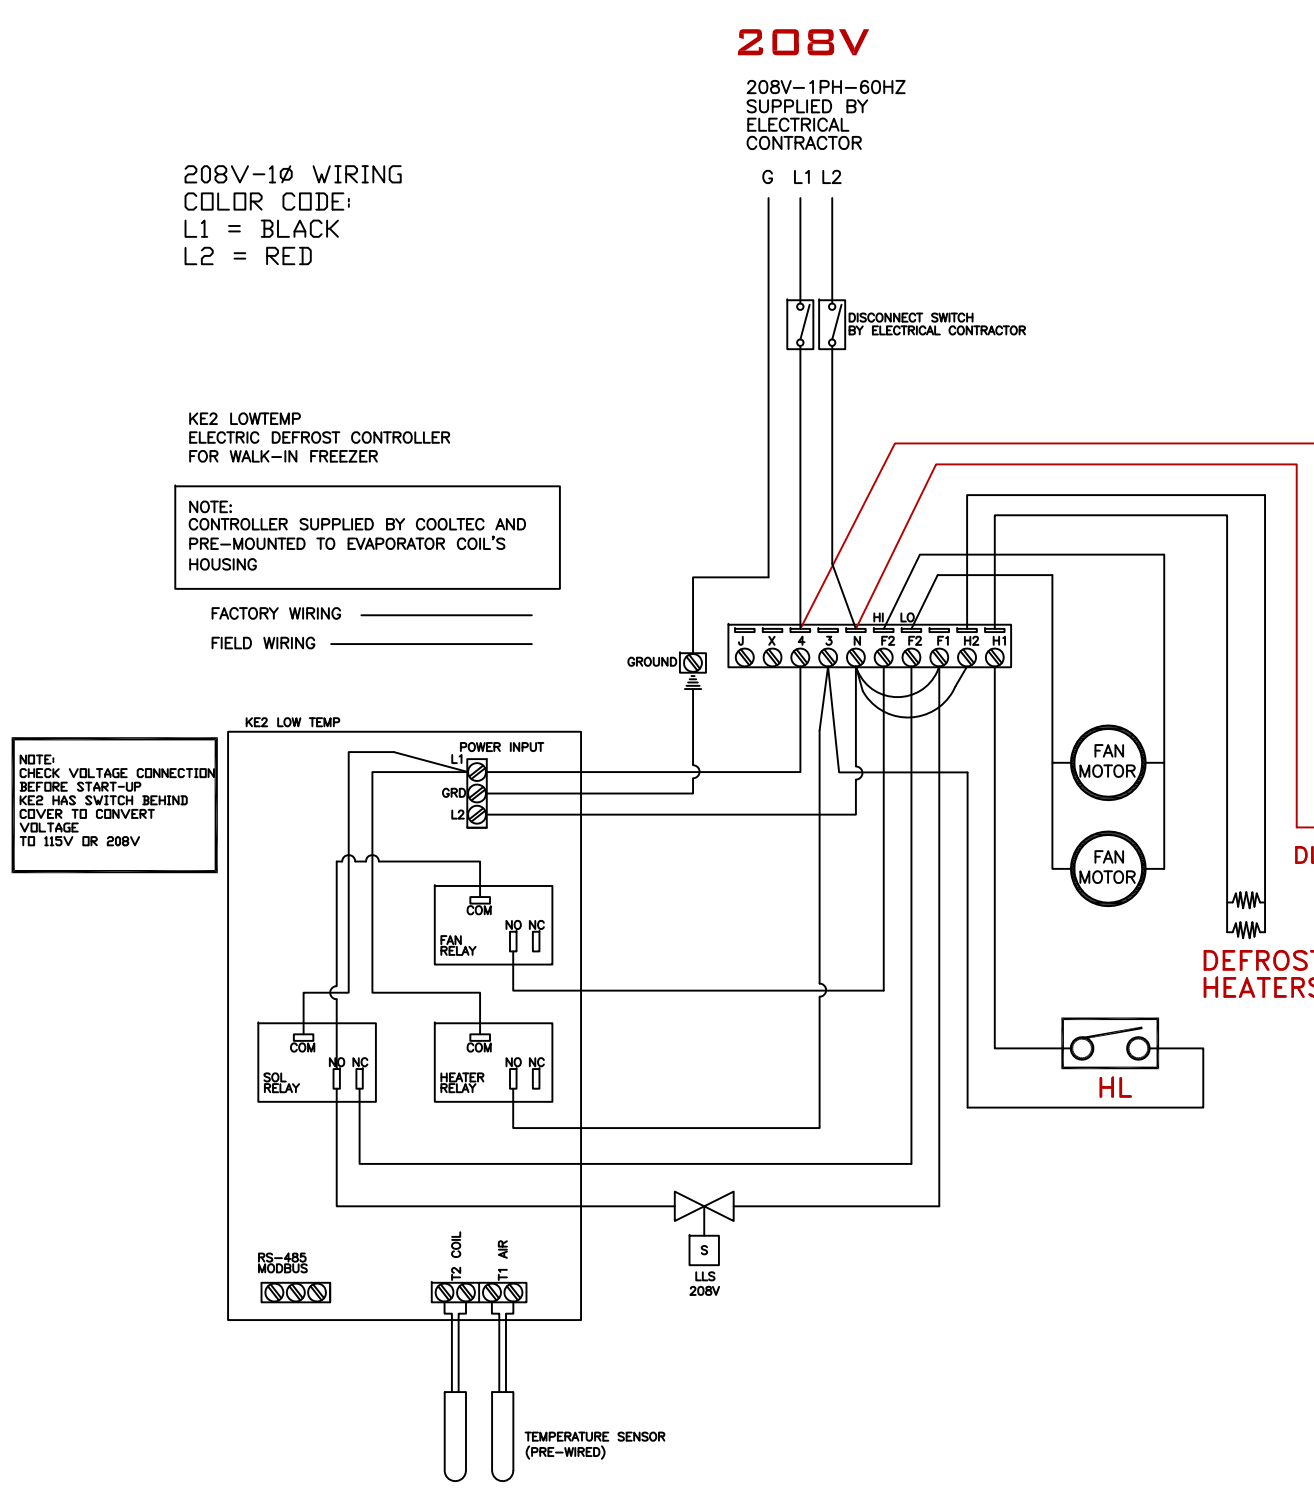
Date
August 24, 2020
Drawn By
Dayne Gauntlett
Scale
1/4" = 1'0"

Sheet
FS-4.0



**POWER REQUIRED FOR LOW TEMPERATURE EVAPORATOR COILS.
POWER FROM BUILDING SUPPLIED BY ELECTRICAL CONTRACTOR**
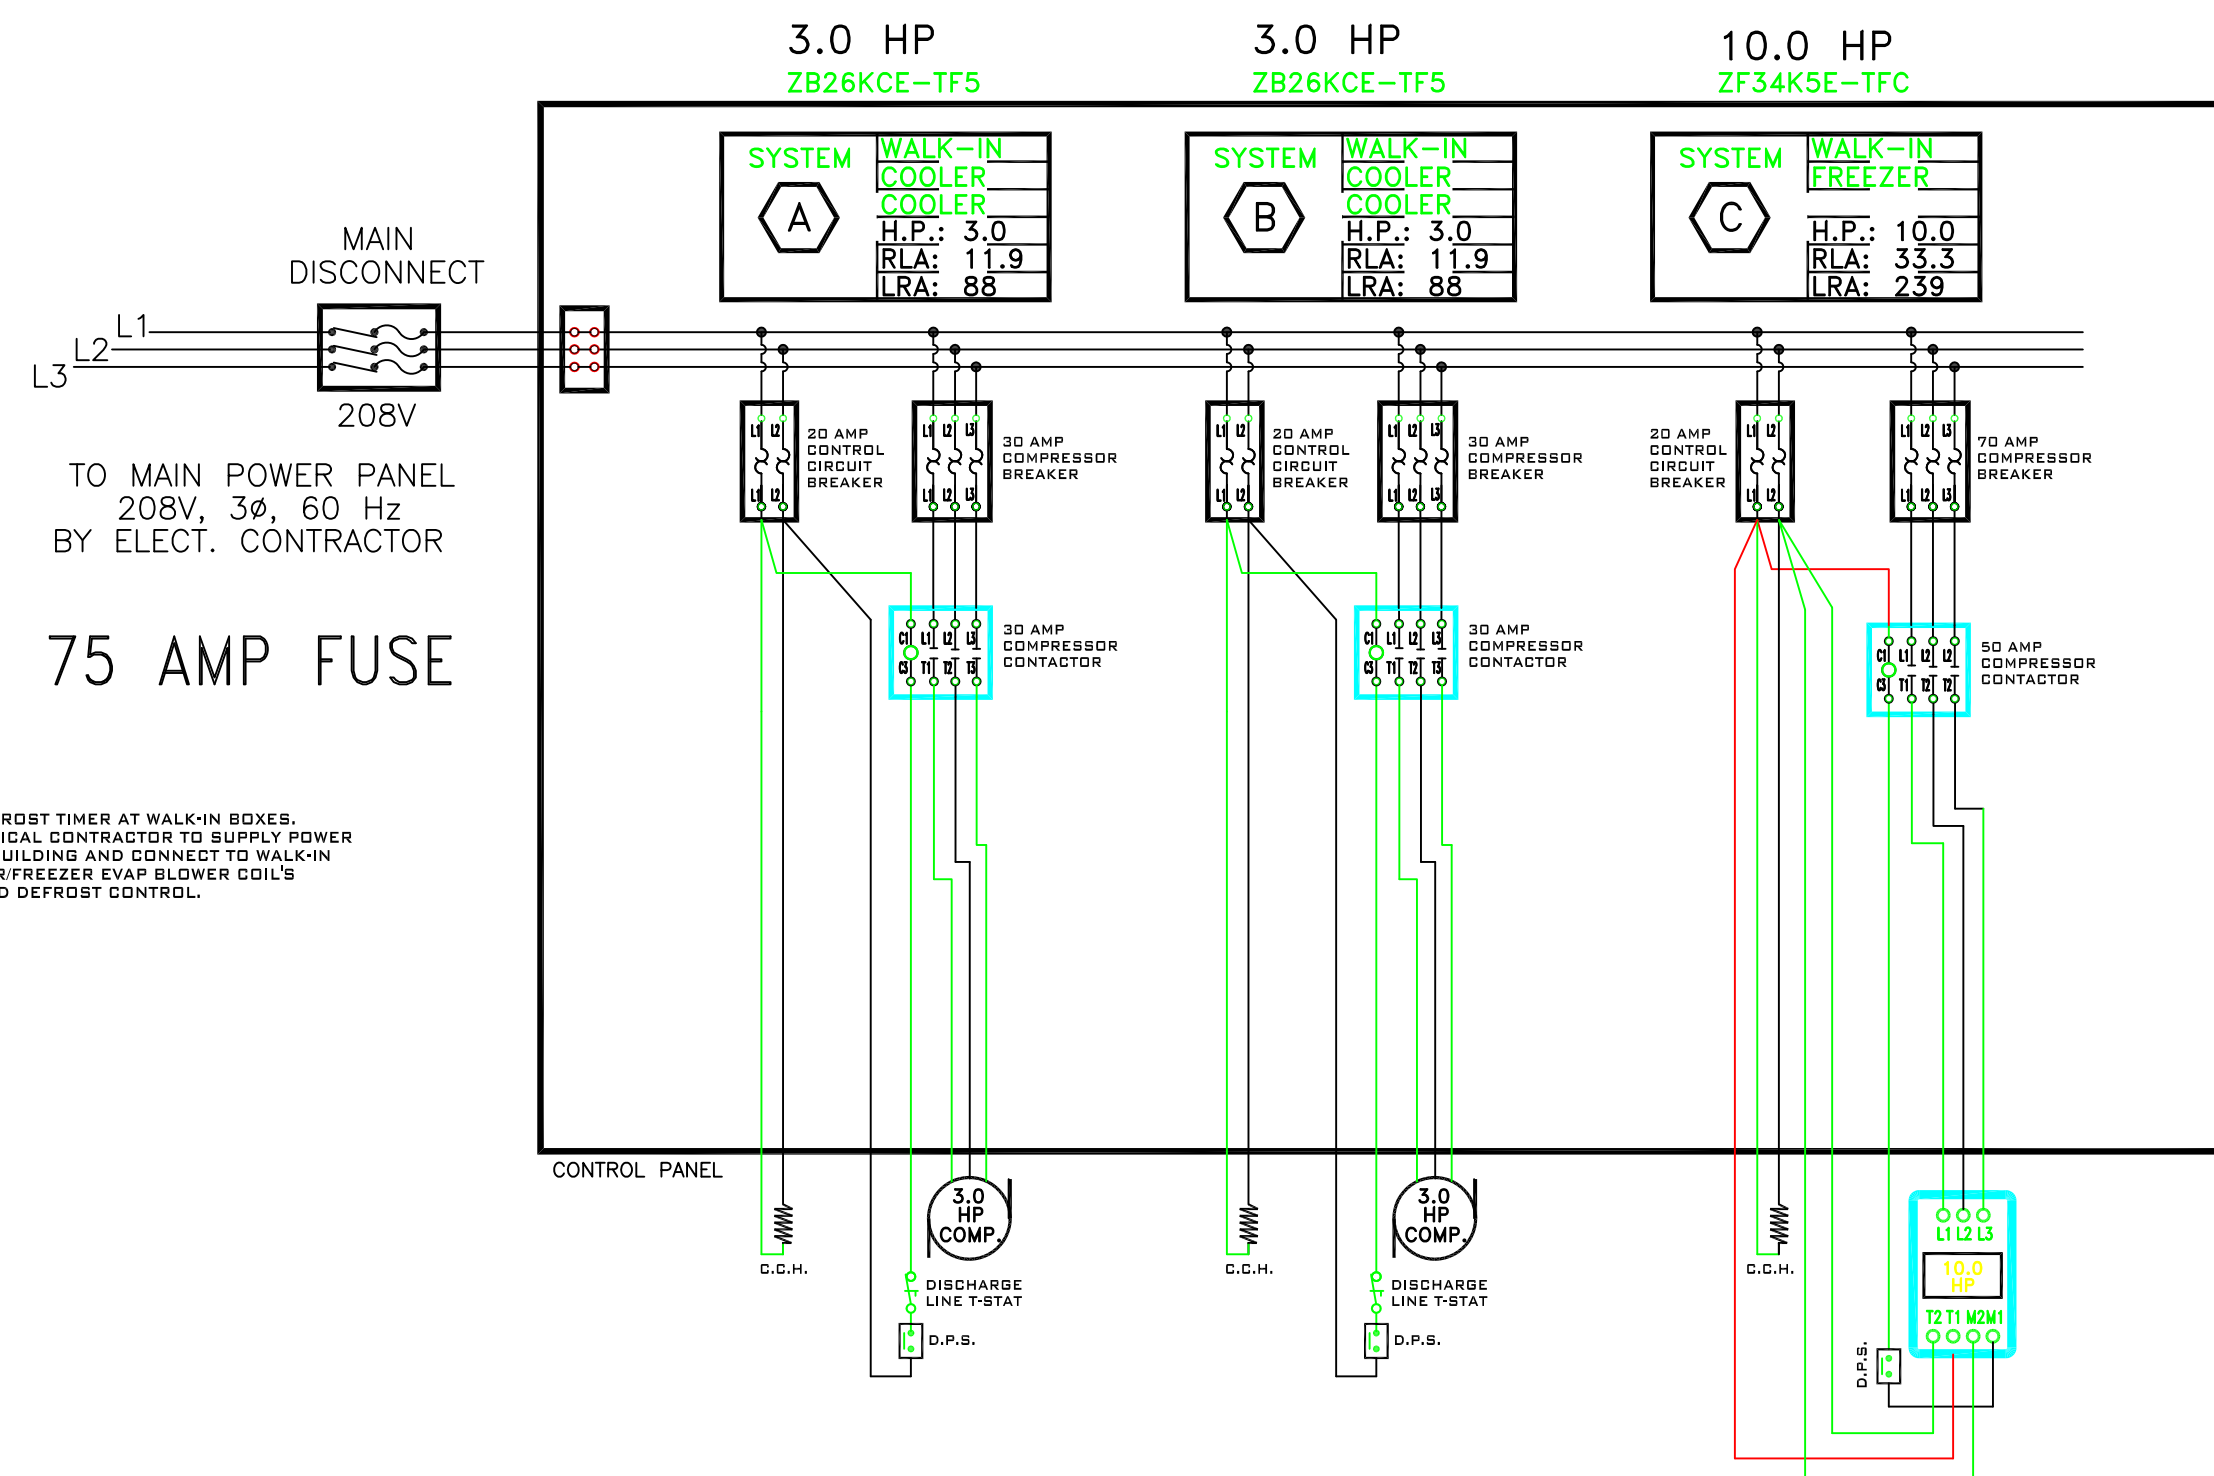
| SYSTEM | DEFROST | ITEM # | DESCRIPTION | QUANTITY | MODEL | POWER FROM BUILDING | | | |
|--------|---------|--------|-----------------|----------|--------------|---------------------|---------|--------------|---------|
| | | | | | | EVAP COIL | | DRAIN HEATER | |
| | | | | | | RLA | VOLTAGE | RLA | VOLTAGE |
| C | D | 11.3 | WALK-IN FREEZER | 1 | BELO080B56MA | 27.4 | 208/1 | 5.0 | 208/1 |




| REV LEVEL | DESCRIPTION | DATE |
|-----------|-------------|----------|
| Δ | SUBMITTAL | 08/04/20 |
| | | |
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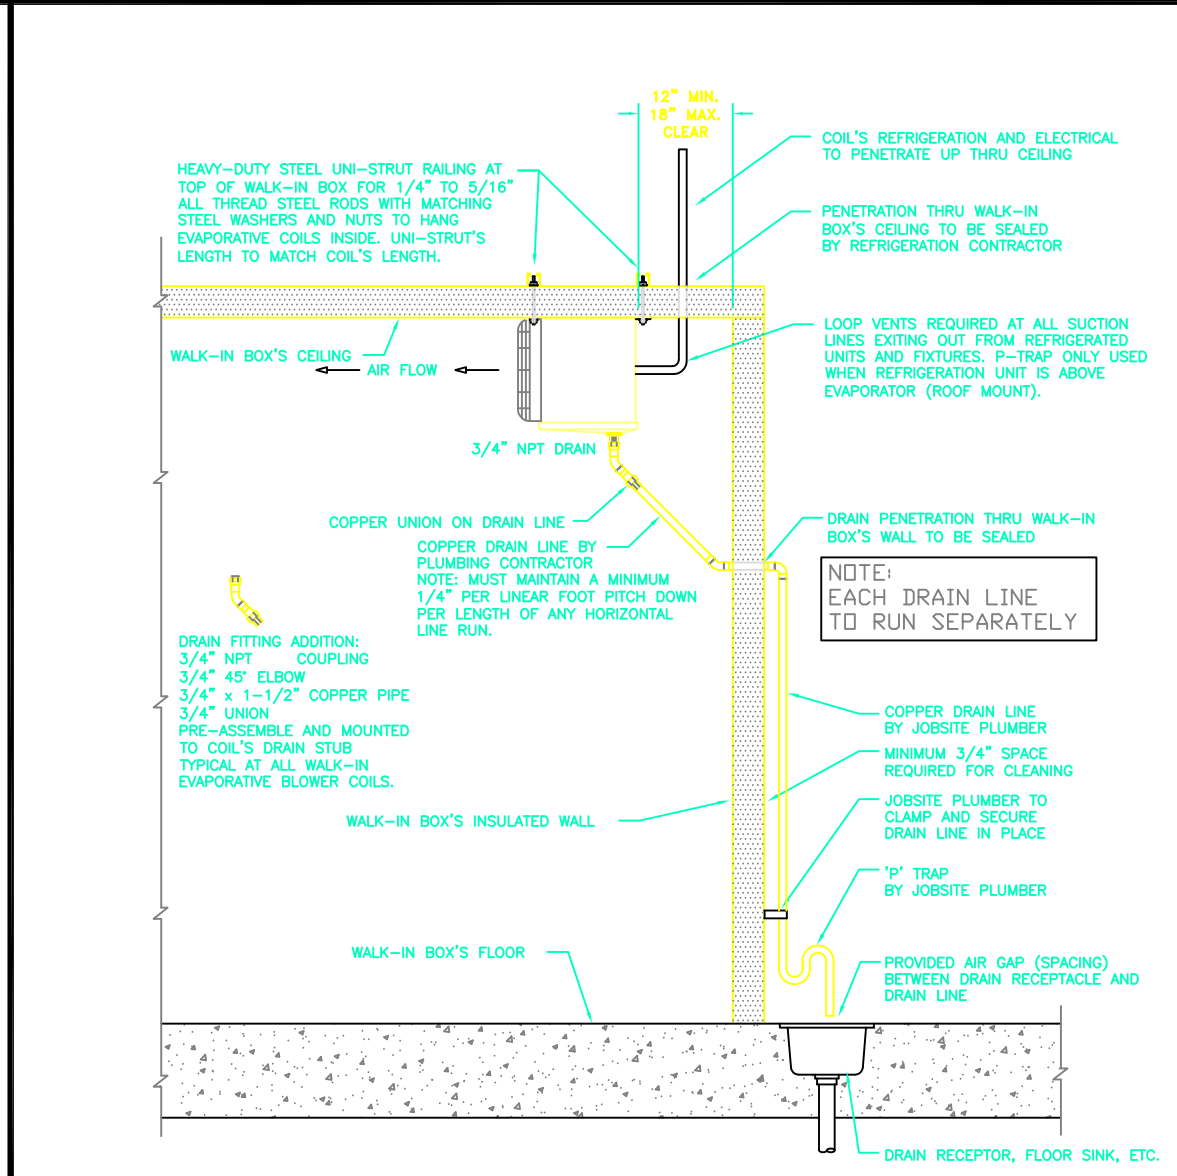
DRAWING APPROVAL
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APPROVED BY: _____ DATE: _____

COOLTEC
REFRIGERATION CORP.
1250 E. FRANKLIN AVENUE, POMONA, CA 91766
PHONE: (909) 865-2229 FAX: (909) 868-0777
E-MAIL: sales@cooltecrefrigeration.com


A
R-2 **WIRING DIAGRAM**

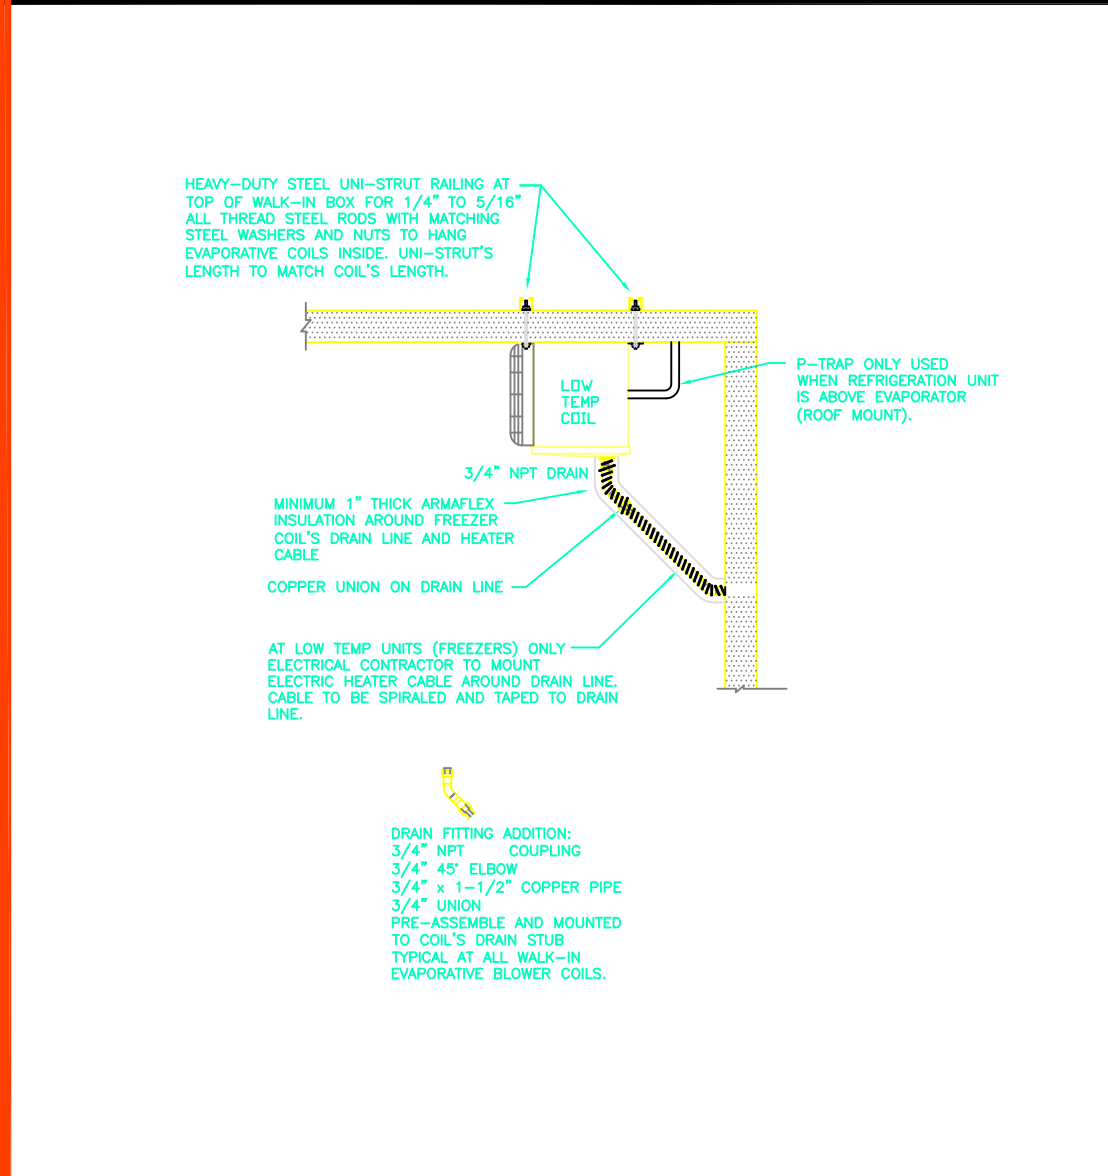

C
R-2 **WALK-IN'S FREEZER CONDENSATE DRAIN LINE**




D
R-2 **WALK-IN'S COIL MOUNT AND CONDENSATE DRAIN LINE**

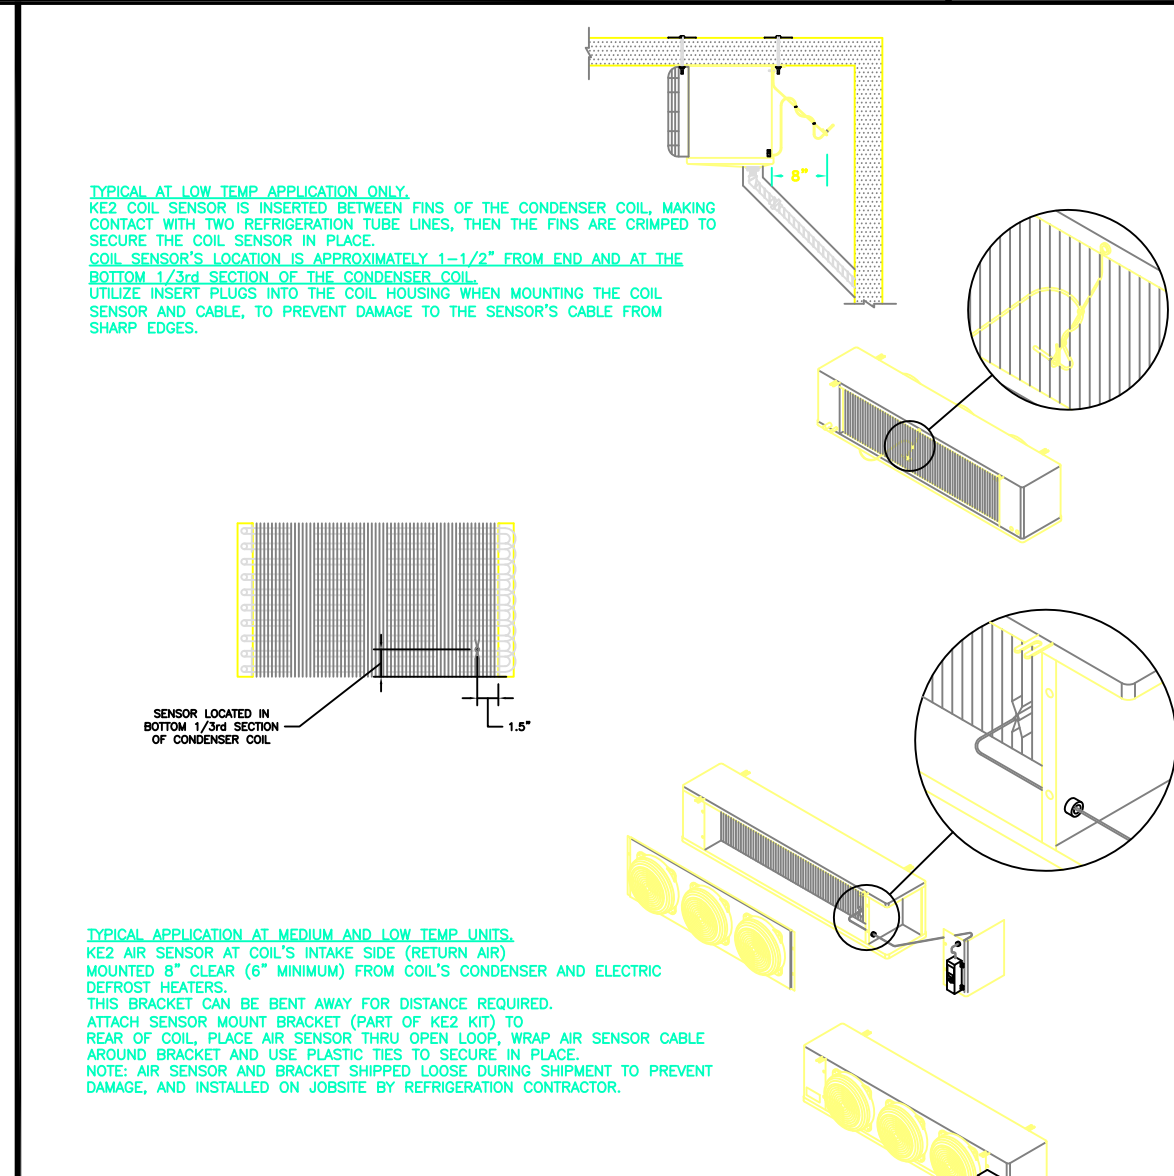

E
R-2 **KE2 TEMP SENSOR MOUNT DETAILS**

**POWER REQUIRED FOR MEDIUM TEMPERATURE EVAPORATOR COILS.
POWER FROM BUILDING SUPPLIED BY ELECTRICAL CONTRACTOR**

| SYSTEM | DEFROST | ITEM # | DESCRIPTION | QUANTITY | MODEL | POWER FROM BUILDING | |
|--------|---------|--------|----------------|----------|---------------|---------------------|---------|
| | | | | | | RLA | VOLTAGE |
| A | D | 11.1 | WALK-IN COOLER | 1 | BELO295AS6AMA | 4.5 | 115/1 |
| B | D | 11.2 | WALK-IN COOLER | 1 | BELO295AS6AMA | 4.5 | 115/1 |

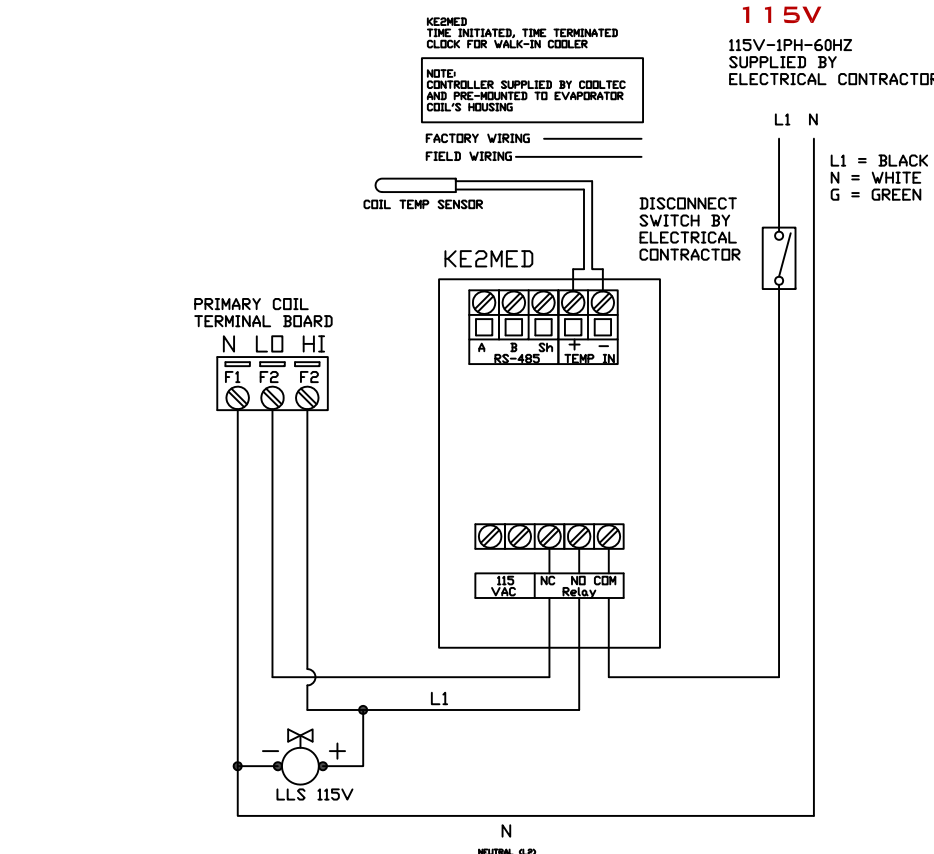

F
R-2 **DEMAND DEFROST- KE2 MED TEMP WIRING DIAGRAM FOR COOLER COIL**

DRAWING TITLE:
REFRIGERATION PLAN
PROJECT NAME:
BAHA MAR BAY BLDG 33
NASSAU, BAHAMAS

DRAWN BY: GF
CHECKED BY: PAUL BEDI
DATE: 08/04/2020
DRAWING NO.: CTR2755
SHEET: 2 OF 2 SHEETS
R-2


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BAHA MAR

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SUPPLY
INTERNATIONAL INC.
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Date
August 24, 2020
Drawn By
Dayne Gauntlett
Scale
NTS

Sheet
FS-6.1



1 PLAN VIEW
SCALE: 1/8"=1'-0"

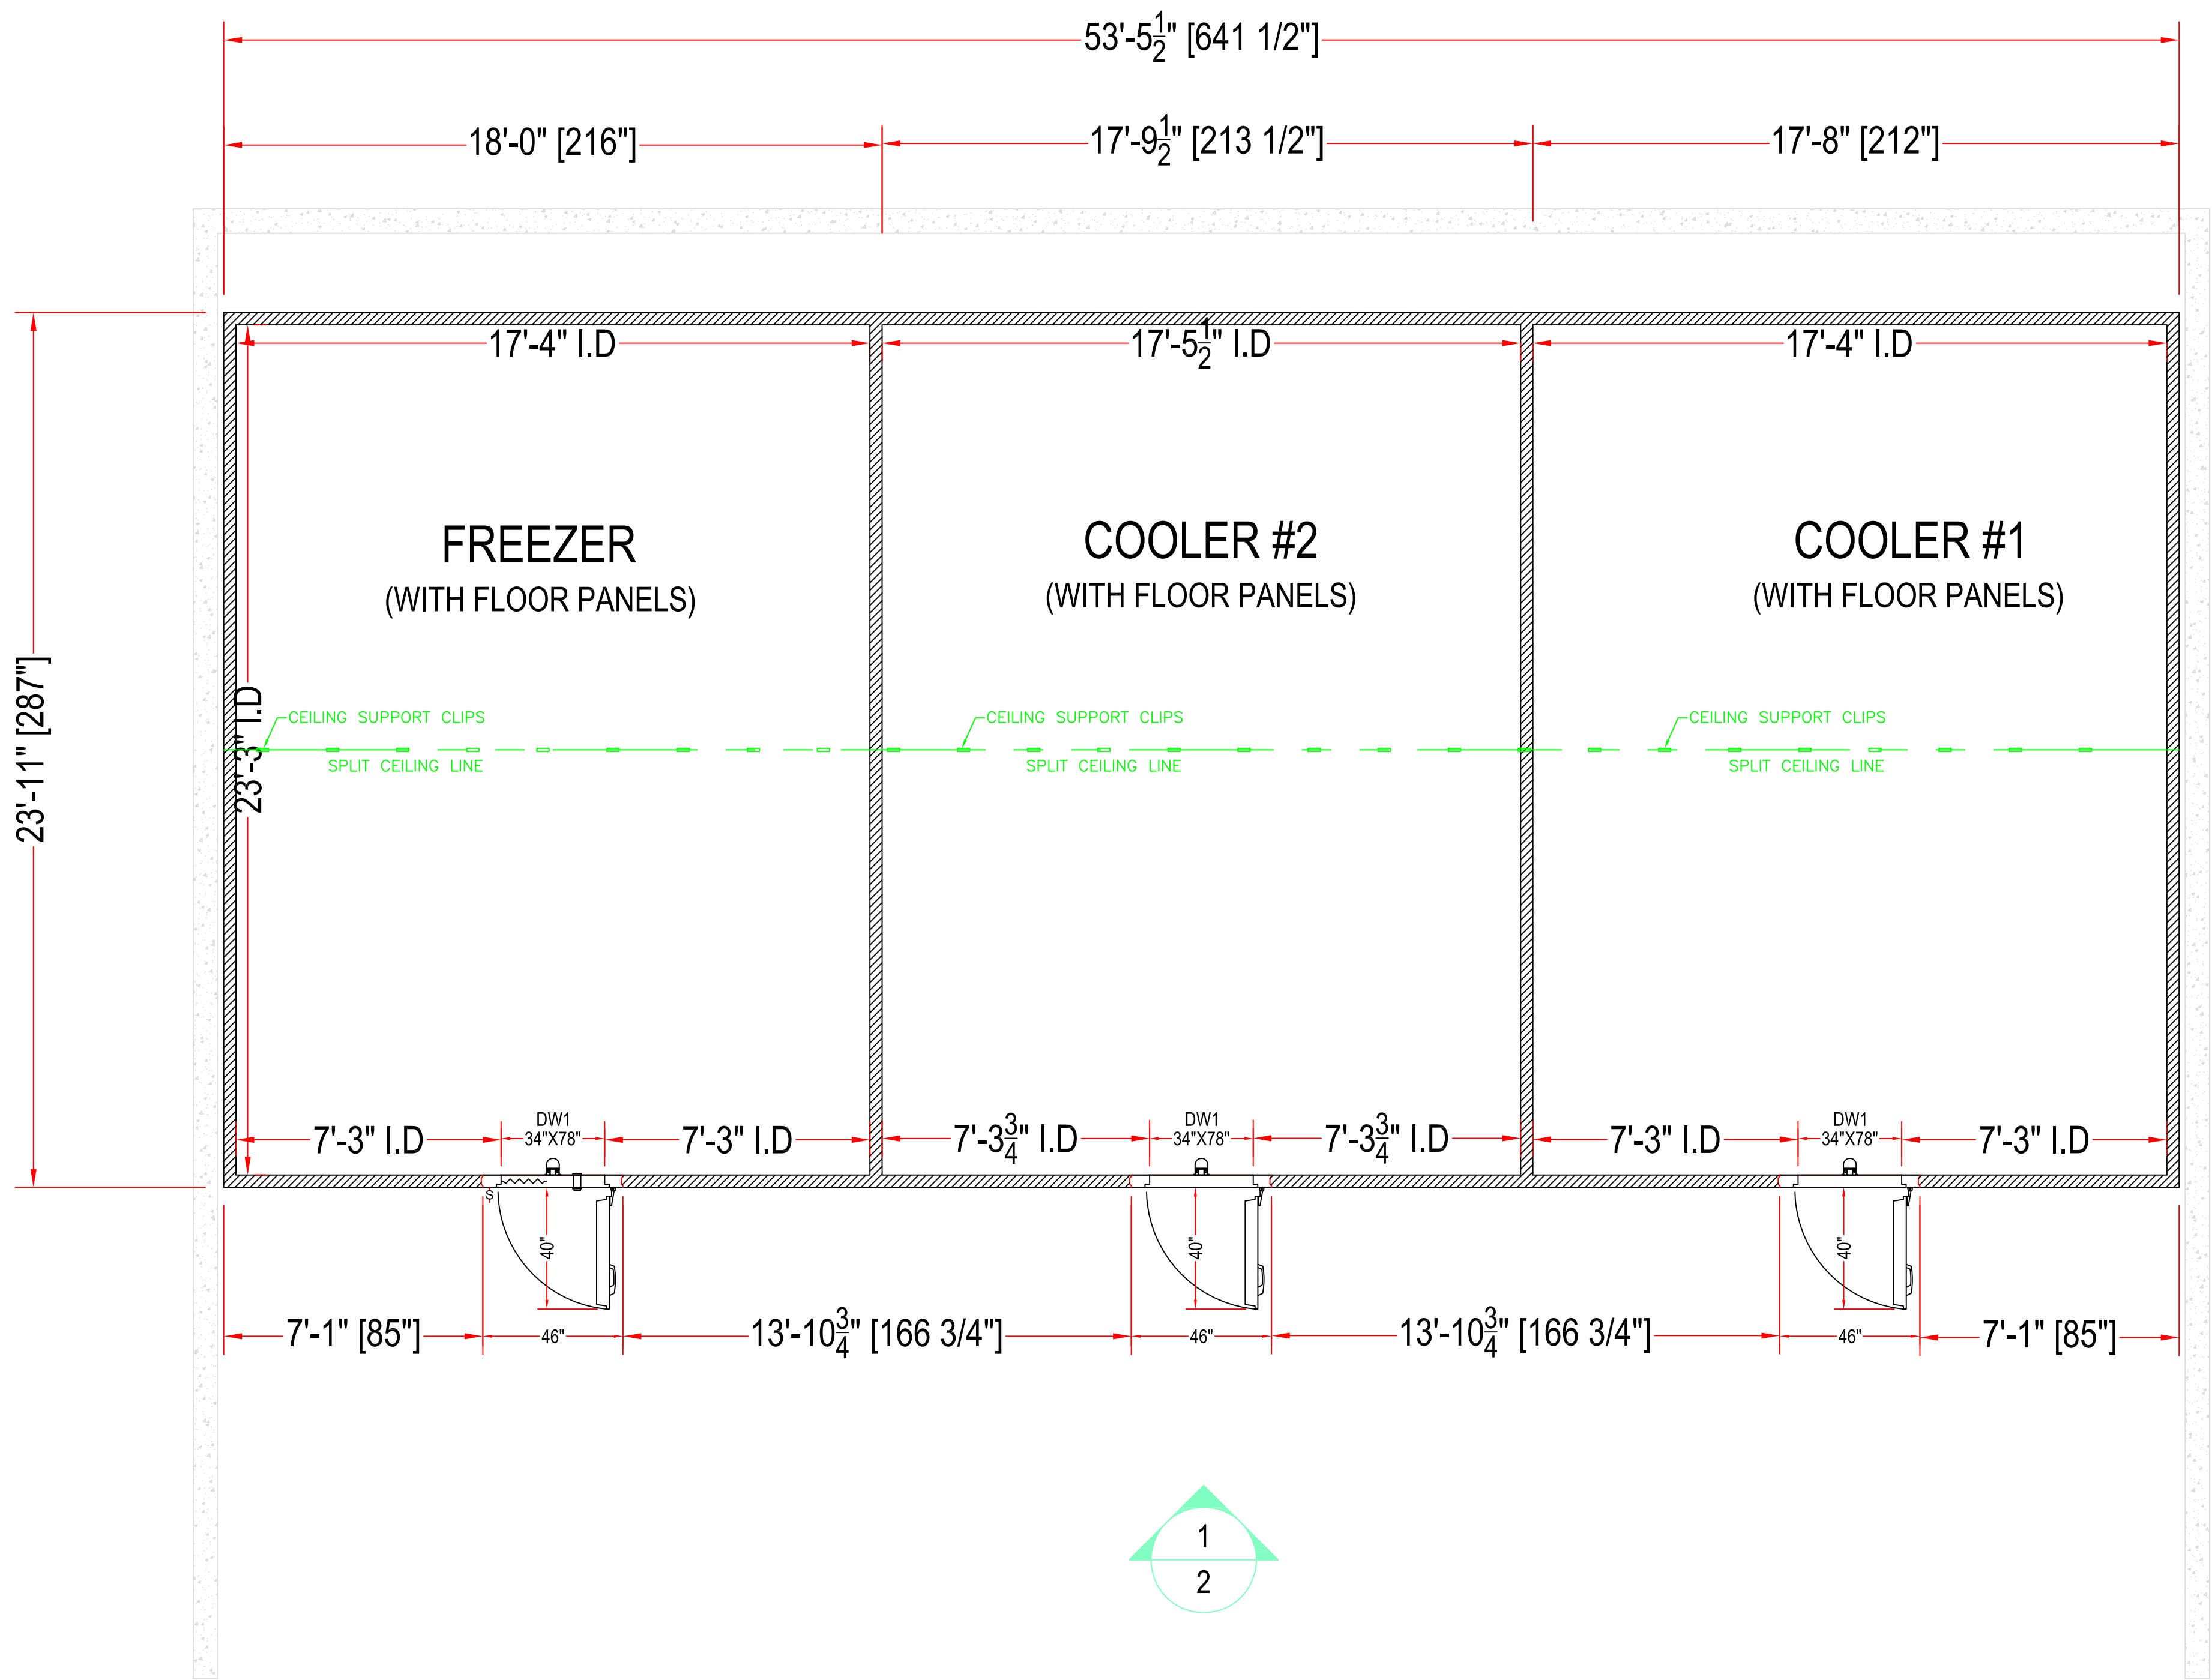Arctic®
WALK-IN COOLERS AND FREEZERS
MIAMI, FLORIDA
PHONE: (305) 883-5581
LOS ANGELES, CALIFORNIA
PHONE: (626) 508-0920
www.arcticwalkins.com



| Revisions: | |
|------------|-----------|
| No. | DATE & BY |
| 1 | ##### |
| 2 | ## |
| 3 | ### |
| 4 | ### |
| 5 | ### |
| 6 | ### |
| 7 | ### |

☐ APPROVED AS DRAWN
☐ APPROVED AS NOTED
☐ RESUBMIT

SIGNED _____

DATE: _____

CONFIDENTIAL

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| | | |
|-------------------------|-------------|-----------|
| Customer Name: | | |
| UNI-SOURCE SUPPLY/EXCEL | | |
| Project Name: | | P.O#: P.O |
| BAHA MAR | | |
| Drawn By: | Checked By: | DRW No: |
| CARMEN | JANET | Q161852 |
| Scale: | Created: | Sheet No: |
| As Shown | 5/02/2006 | 1 TO 5 |

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Building 33 (Cup B)
Nassau Bahamas

BAHA
MAR




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Date
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Drawn By
Dayne Gauntlett
Scale
NTS

Sheet
FS-7.0



1 ELEVATION
SCALE: 1/8"=1'-0"

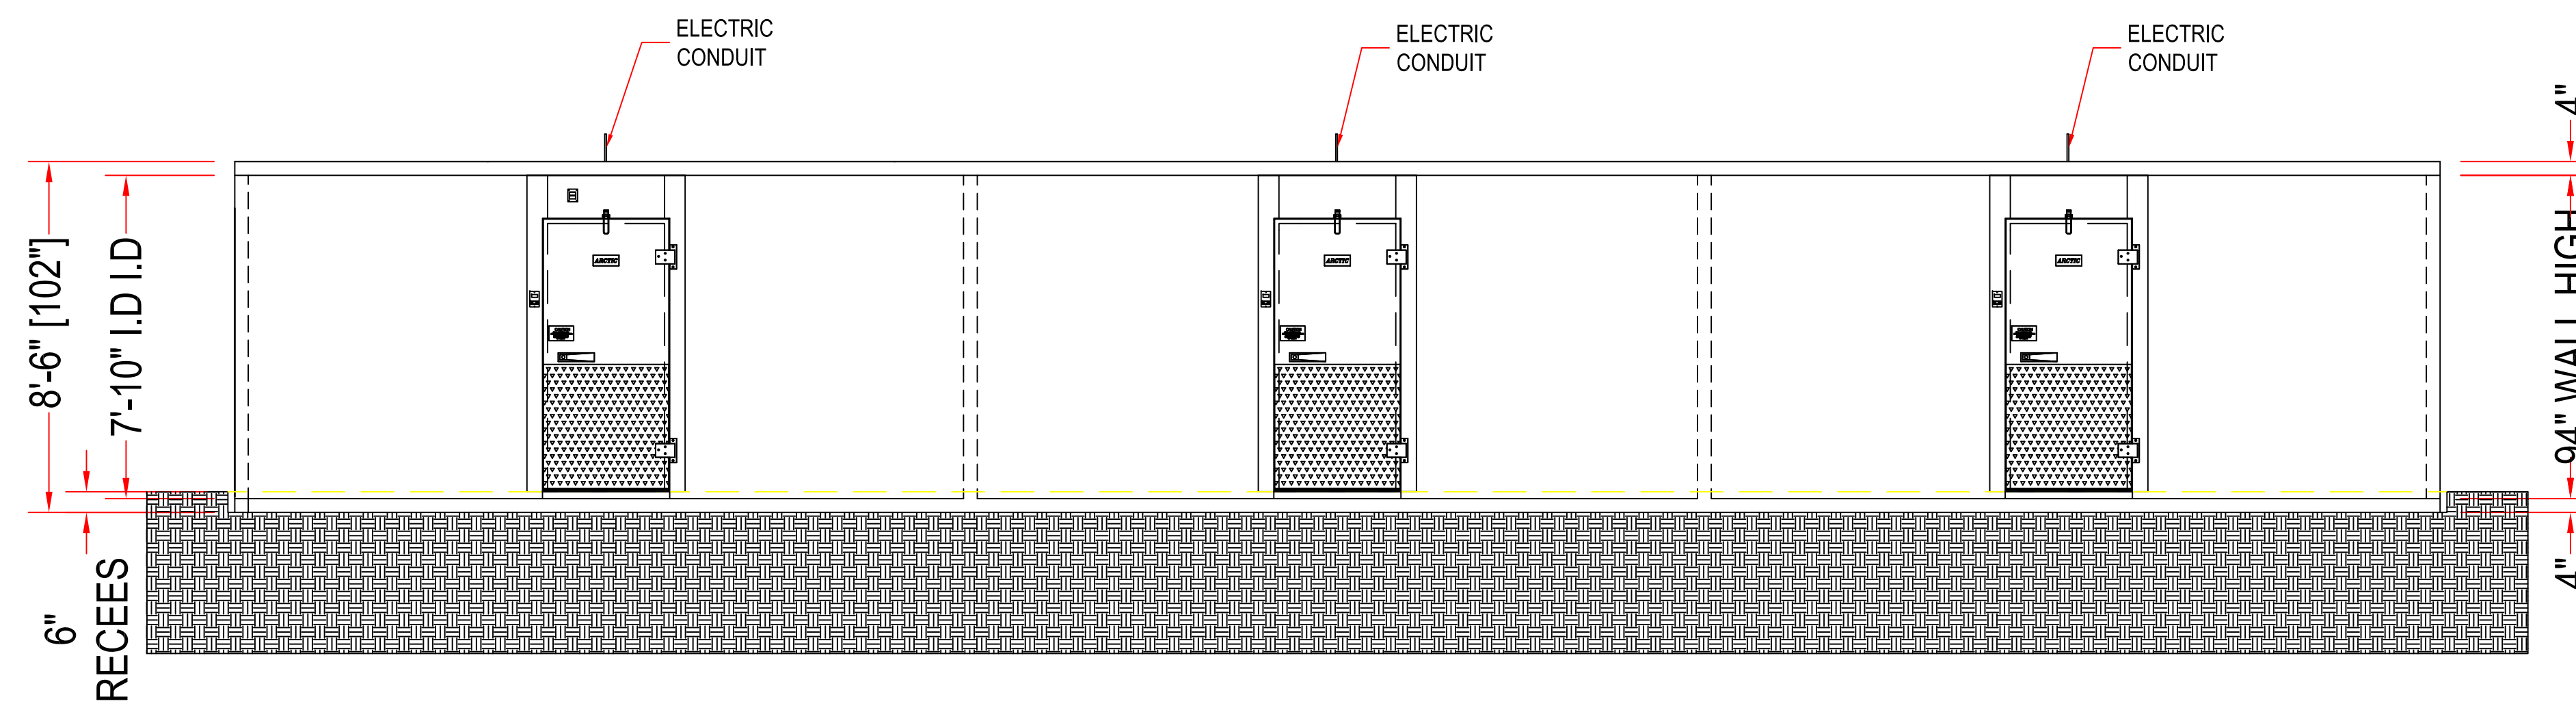☐ APPROVED AS DRAWN
☐ APPROVED AS NOTED
☐ RESUBMIT

SIGNED _____

DATE: _____

WALK-IN COOLERS AND FREEZERS
MIAMI, FLORIDA
PHONE: (305) 883-5581
www.arcticwalkins.com
LOS ANGELES, CALIFORNIA
PHONE: (626) 508-0920

Intertek
CONFORMS TO
NSF STD 7

Intertek
CONFORMS TO
UL STD 471

Customer Name:
UNI-SOURCE SUPPLY/EXCEL

Project Name:
BAHA MAR

P.O.#: P.O.

| | | |
|-----------|-------------|-----------|
| Drawn By: | Checked By: | DRW No: |
| CARMEN | JANET | Q161852 |
| Scale: | Created: | Sheet No: |
| As Shown | 5/02/2006 | 2 TO 5 |

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Date
August 24, 2020



Drawn By
Dayne Gauntlett

Scale
NTS

Sheet

FS-7.1

| CONSTRUCTION: | | | | | | | | | | | | | | |
|--|---|-----------|-----------|-------------|---------|--------|-------|---------|--------|----------|-----------|----------|-----------|--------|
| 4" POLYURETHANE FOAM IN PLACE PANELS, R-VALUE R28 FOR COOLER AND R32 FOR FREEZER, ASTM E84 / UL 723 INNER FOAM CORE; FLAME SPREAD ≤25, SMOKE DEVELOPED ≤450 | | | | | | | | | | | | | | |
| PANEL FINISHES | DOOR DESCRIPTION | | | | | | | | | | | | | |
| WALL INTERIOR: WALL EXTERIOR: | FREEZER DOOR: INTERIOR FINISH: 26 GAUGE MILL EMBOSSED ACRYLUME EXTERIOR FINISH: 26 GAUGE MILL EMBOSSED ACRYLUME COOLER DOOR: INTERIOR FINISH: 26 GAUGE MILL EMBOSSED ACRYLUME EXTERIOR FINISH: 26 GAUGE MILL EMBOSSED ACRYLUME NOTES: | | | | | | | | | | | | | |
| CEILING INTERIOR: CEILING EXTERIOR: | | | | | | | | | | | | | | |
| FLOOR INTERIOR: FLOOR EXTERIOR: | | | | | | | | | | | | | | |
| ACCESSORIES: HINGE MODEL: KASON 1255 BRUSHED CHROME DOOR CLOSURE KASON 1094 WHOOK HANDLE KASON 1229C BRUSHED CHROME 36" DTP KICKPLATE INT. & EXT. VAPOR LIGHT - KASON 1804LG W/ NIGHT LIGHT ARCTIC LED DIGITAL THERMOMETER/SINGLE POLE LIGHT SWITCH HEATED WIRE & PRV (FREEZER) | | | | | | | | | | | | | | |
| WALK-IN ACCESSORIES | | | | | | | | | | | | | | |
| (56) - FT FEET OF CEILING SUPPORT 4" CLIPS (3) - EA AIR CURTAIN, PLASTIC STRIP (UP TO 41" X 80" DOOR) | | | | | | | | | | | | | | |
| NOTE: SEE LAST PAGE FOR DETAILS | | | | | | | | | | | | | | |
| GENERAL NOTES | | | | | | | | | | | | | | |
| FLOOR MUST BE LEVEL WITHIN 3/16" PER 10'. SMOOTH, AND CLEAR OF OBSTRUCTIONS PRIOR TO INSTALLING WALK-IN PANELS. | | | | | | | | | | | | | | |
| A 2" MINIMUM GAP ALL AROUND WALK-IN IS REQUIRED FOR PROPER AIR CIRCULATION. HIGH HUMIDITY ENVIRONMENTS MAY REQUIRE FORCED VENTILATION IN GAP TO PREVENT CONDENSATION. | | | | | | | | | | | | | | |
| FLOOR PANELS (WHEN PROVIDED) ARE DESIGNED TO WITHSTAND A 800 POUND PER SQUARE FOOT STATIONARY LOAD. DAMAGE DUE TO FORKLIFTS, PALLET JACKS, CARTS, OR ANY TYPE OF ROLLING TRAFFIC IS NOT COVERED BY WARRANTY. | | | | | | | | | | | | | | |
| STANDARD PANELS HAVE A STUCCO-EMBOSSED FINISH (TEXTURE) THAT HELPS REDUCE IRREGULARITIES IN THE PANEL SURFACE. ON REQUEST WE WILL PROVIDE A NON-TEXTURED (SMOOTH FINISH). SMOOTH FINISH PANELS TYPICALLY EXPERIENCE WRINKLING AND OTHER FLATNESS IMPERFECTIONS SUCH AS OIL-CANNING WHICH IS NOT COVERED BY WARRANTY. | | | | | | | | | | | | | | |
| WALK-IN ROOF IS NOT DESIGNED FOR FOOT TRAFFIC OR STORAGE. SNOWICE LOADS (OUTDOOR BOXES); TO AVOID CEILING FAILURE/COLLAPSE DUE TO SNOW OR ICE (NOT COVERED BY PANEL WARRANTY), SNOW OR ICE ACCUMULATION OF MORE THAN 3' MUST BE CAREFULLY REMOVED IN A MANNER WHICH DOES NOT CAUSE DAMAGE OR TEAR THE MEMBRANE ROOF COVER. | | | | | | | | | | | | | | |
| FOR QUARRY TILE OR CONCRETE FLOORS, THE METAL FACING MAY BE SUSCEPTIBLE TO STAINING DUE TO MOISTURE CREATED BY HYDRATION OF CONCRETE-TYPE MATERIALS. EACH ROOM MUST BE PROPERLY VENTILATED AND SPECIAL PRECAUTIONS TAKEN WHEN USING MURIATIC ACID DUE TO ITS EFFECTS ON ALUMINUM, GALVANIZED STEEL, AND STAINLESS STEEL. | | | | | | | | | | | | | | |
| METAL SURFACE MUST BE PROTECTED FROM LIME AND CONCRETE RELATED COMPONENTS. PROTECTION OF ONE OF THE FOLLOWING TYPES MUST BE APPLIED BETWEEN THE CONCRETE AND METAL SURFACES: LIQUID TAR BRUSHED OR SPRAYED ABOVE THE CONCRETE LINE, HEAVY EPOXY PAINT, 6 MIL POLYETHYLENE, OR A DOUBLE LAYER OF 30 LB ASPHALT IMPREGNATED ROOFING PAPER. | | | | | | | | | | | | | | |
| REFRIGERATION SYSTEM BY OTHERS | | | | | | | | | | | | | | |
| <div><div>Arctic® WALK-IN COOLERS AND FREEZERS MIAMI, FLORIDA PHONE: (305) 854-5581 LOS ANGELES, CALIFORNIA PHONE: (310) 556-0205 www.arctic-us.com</div><div>Intertek Customer No. 125-122-01 Intertek CORPORATE ID NO. 125-122-01</div><div>EISA</div></div> <div>Customer Name: UNI-SOURCE SUPPLY/EXCEL Project Name: BAHA MAR</div> <div>Signed _____ Date: _____ P.O.#: P.O.</div> <table border="1"><thead><tr><th>Drawn By:</th><th>Checked By:</th><th>DRV No:</th></tr></thead><tbody><tr><td>CARMEN</td><td>JANET</td><td>Q161852</td></tr><tr><td>Scale:</td><td>Created:</td><td>Sheet No:</td></tr><tr><td>As Shown</td><td>5/02/2006</td><td>3 TO 5</td></tr></tbody></table> | | | Drawn By: | Checked By: | DRV No: | CARMEN | JANET | Q161852 | Scale: | Created: | Sheet No: | As Shown | 5/02/2006 | 3 TO 5 |
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**Baha Mar Bay
Building 33 (Cup B)
Nassau Bahamas**

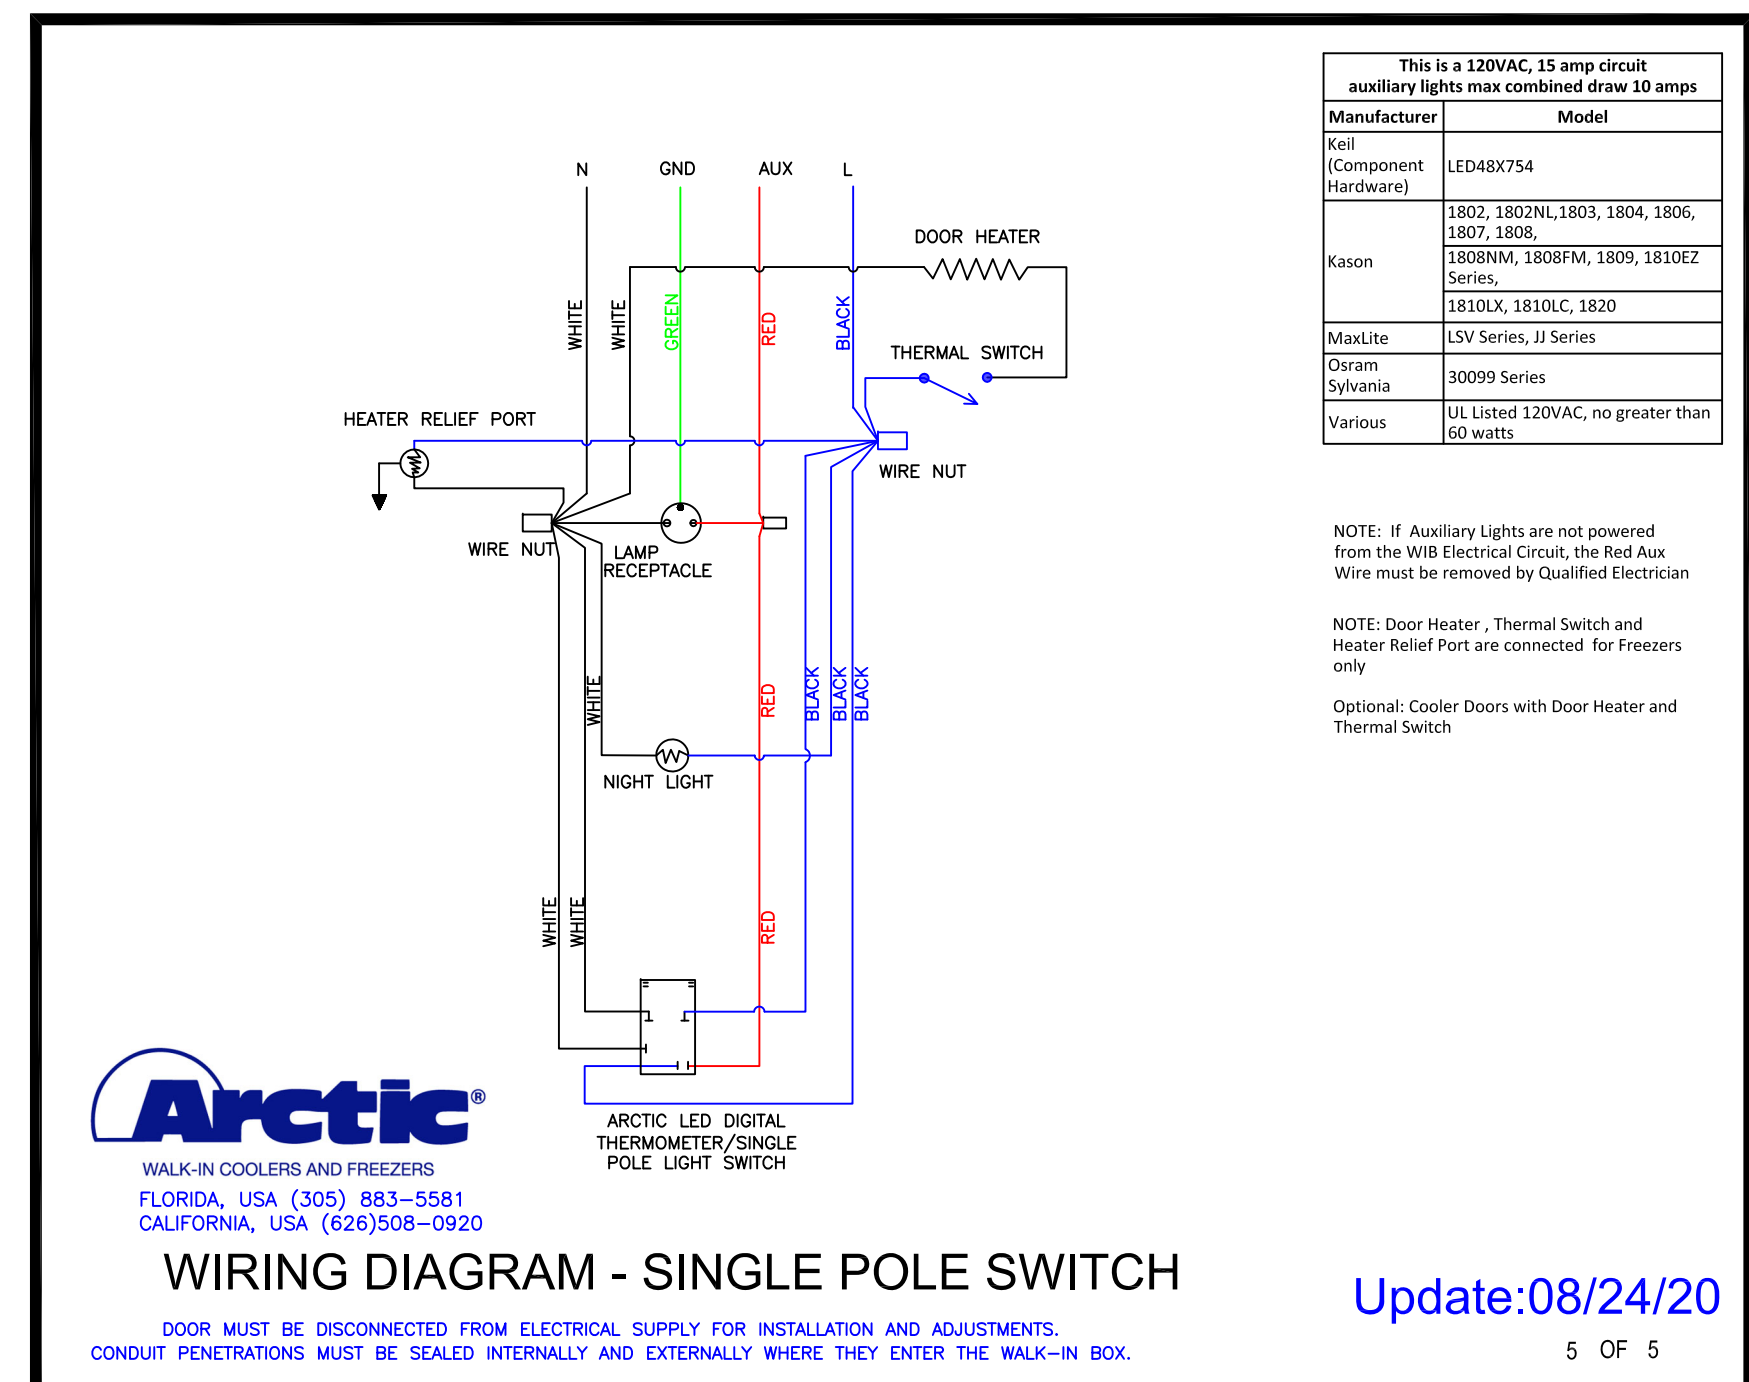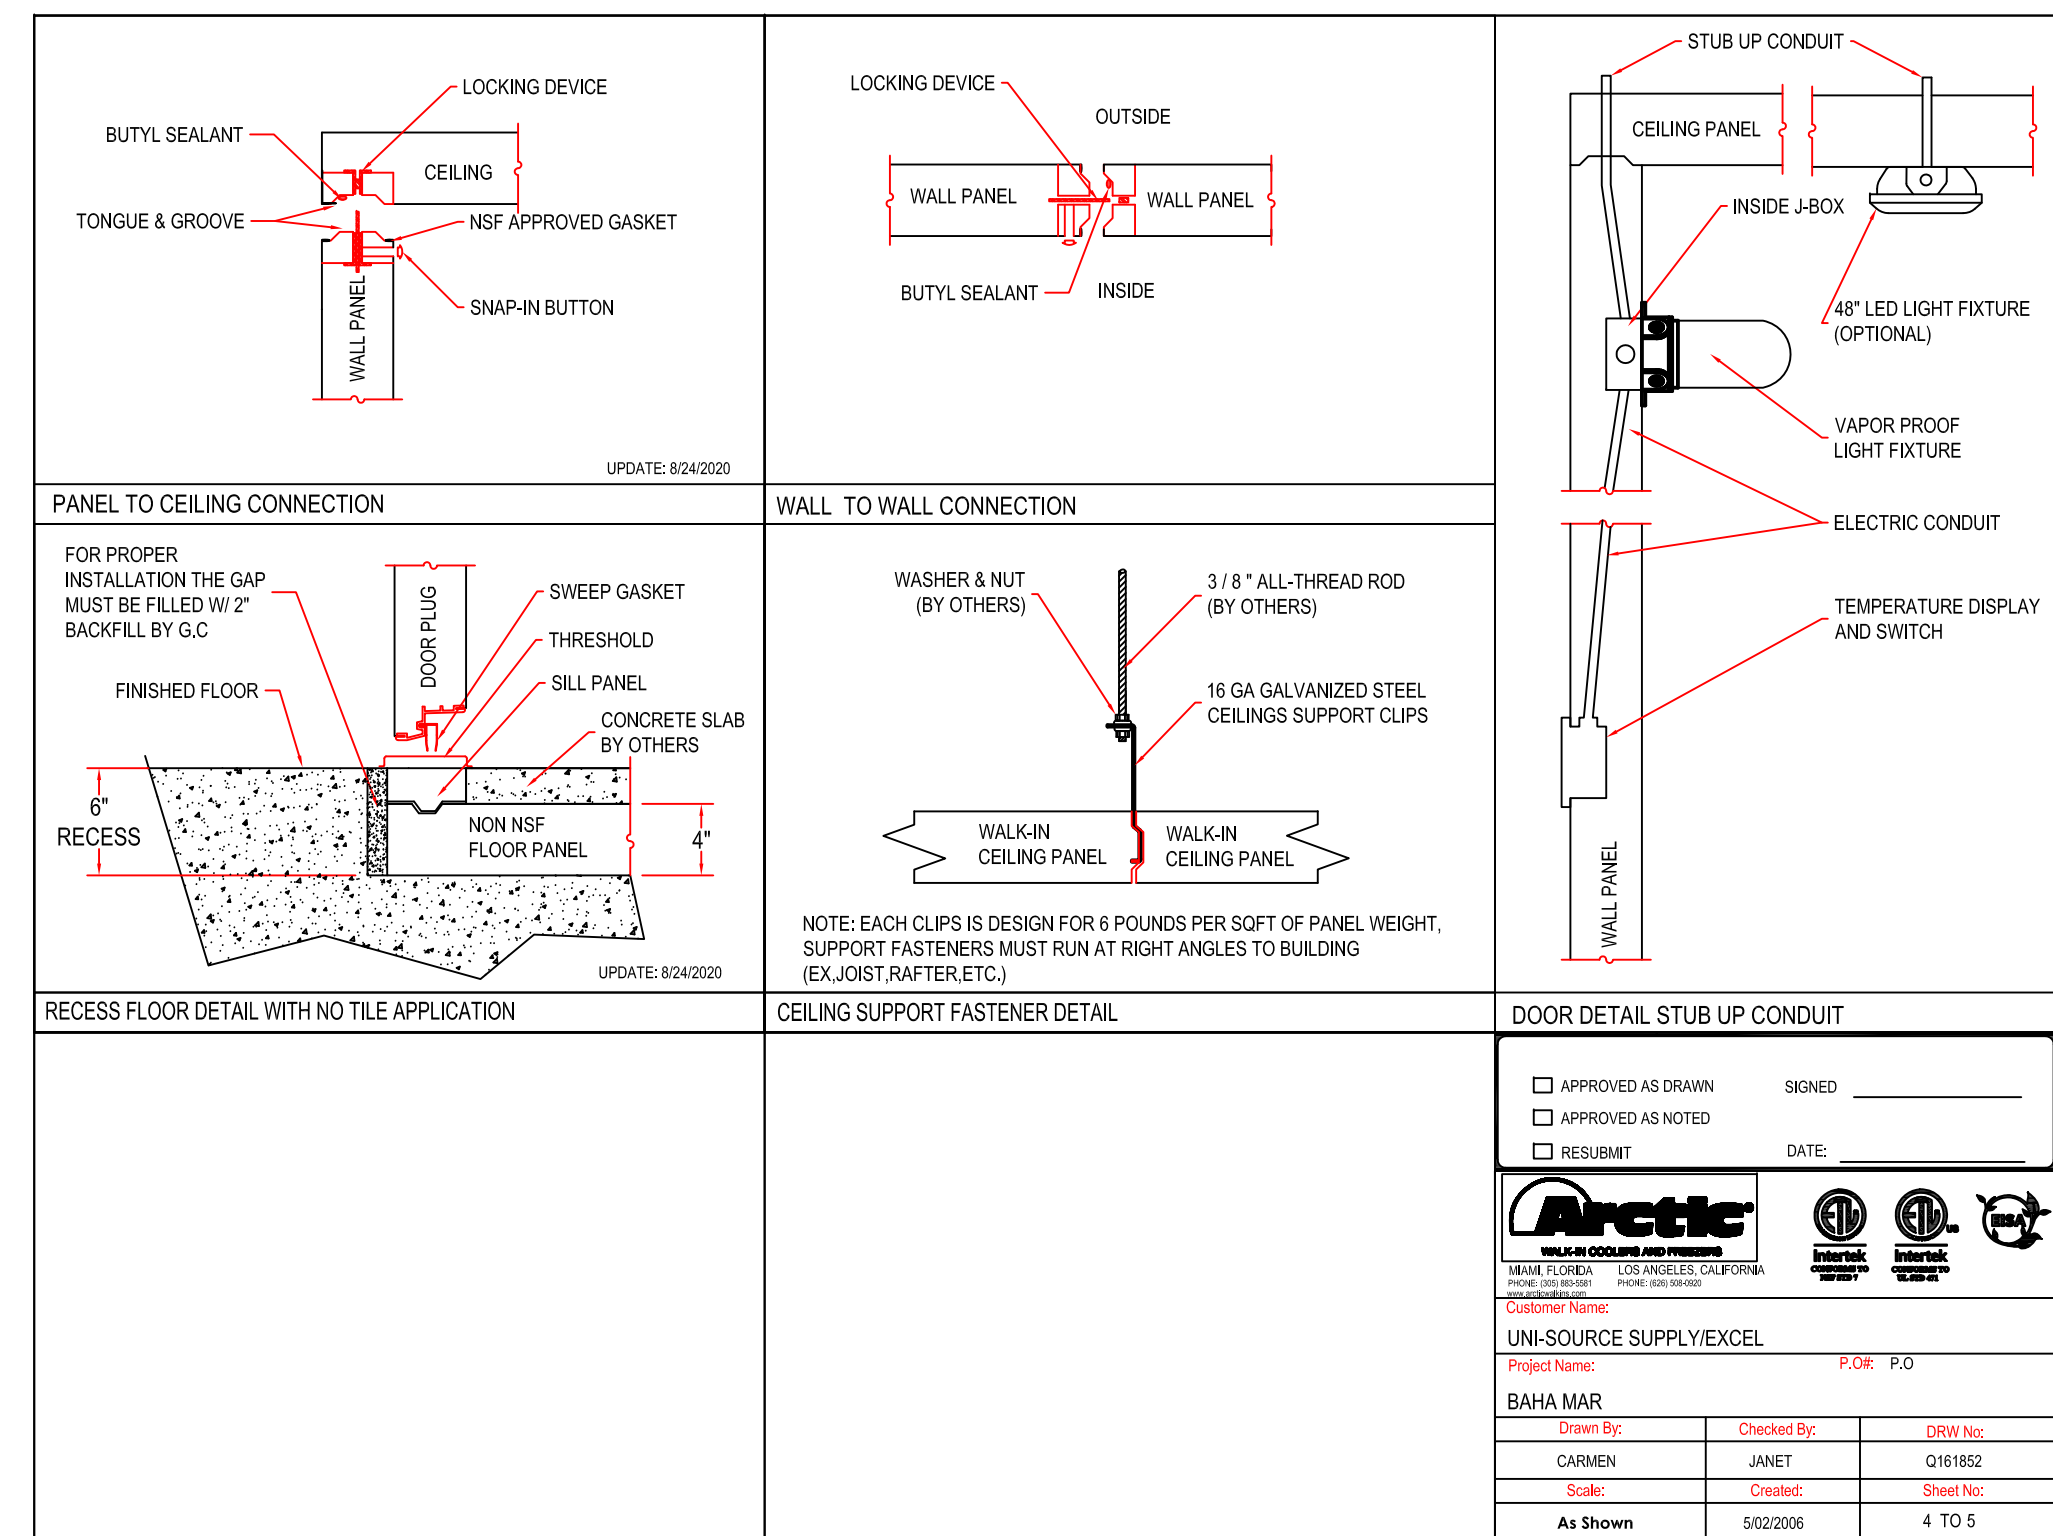

uni-source
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INTERNATIONAL INC.

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| | | |
|-----|--|---------|
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