

EQUIPMENT SCHEDULE					
ItemNo	Category	Mfr	Model	Quantity	Equipment Remarks
1	Washer Extractor	UNIMAC	UC60	1	
2	Washer Extractor	UNIMAC	UC30	1	Existing
3	Washer Extractor	UNIMAC	UC80	1	
4	Drying Tumbler	UNIMAC	UT075	2	Electric Heat
5	Drying Tumbler	UNIMAC	CT040-E-QT	1	Existing
7	Hand Sink	Advance Tabco	7-PS-55	1	
8	Work Table, Stainless Steel Top	Millwork	TSS-366	1	By Millwork
9	One (1) Compartment Sink	Advance Tabco	FC-1-1620-18L	1	
	Wall / Splash Mount Faucet	Advance Tabco	K-112	1	
10	Spare Number				
11	Cart, Laundry	Steele	092014	6	
12	Chemical Pump	Ecolab	CHEM	3	
13	Flatwork Ironer	ChDryer	EO-16X120	1	Electric Heat
101	Freight	UNI	FREIGHT	1	
102	Freight	Owner	FREIGHT	1	
103	Installation	UNI	INSTALL	1	
Z108	Installation - Fans & Ductwork	GC	INSTALL	1	
Z109	Installation - Materials	UNI	INSTALL	1	

EQUIPMENT LAYOUT

All Dimensions to be verified on the job site.
 Actual locations for floor drains, and any ventilating equipment to be determined by Engineer.
 Mechanical, Plumbing & Electrical to be checked and verified by Customers MEP Engineer.
 Remote Condensing Units to be located by Architect.
 Exhaust & Supply fans to be located by Architect.

The Brix Hotel
 Laundry
 Trinidad & Tobago

AUTOGRAPH
 COLLECTION™






INTERNATIONAL INC.

2055 W 73rd Street, Miami, FL 33016
 Ph: (305)826-8696 Fax: (305)826-9131

2	Changed Dryers to Electric Heat	2-21-20
3	Update based on Owner comments and site review.	3-11-20
4	Changed ironer to Electric Heat.	3-12-20
5	Added MEP information.	7-31-20
No.	Revision/Issue	Date

Date
 July 31, 2020
 Drawn By
 Dayne Gauntlett
 Scale
 3/8" = 1'0"

Sheet
ML-1

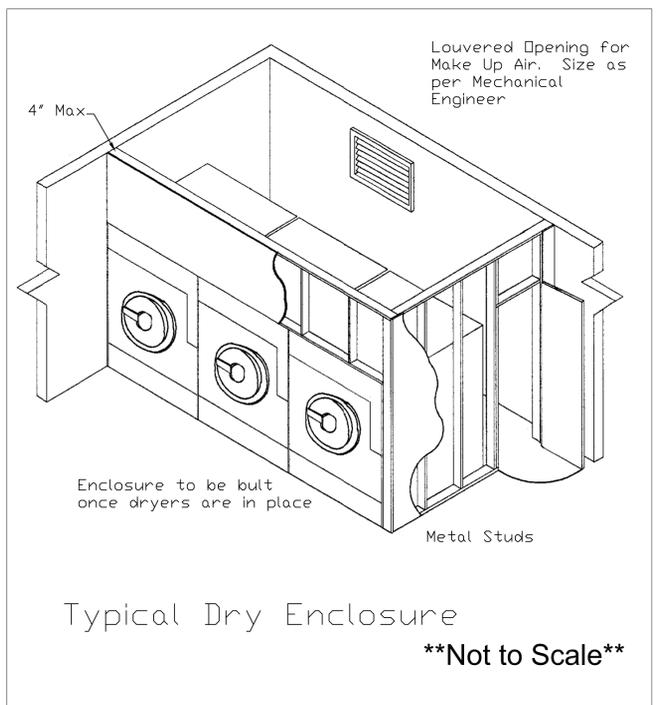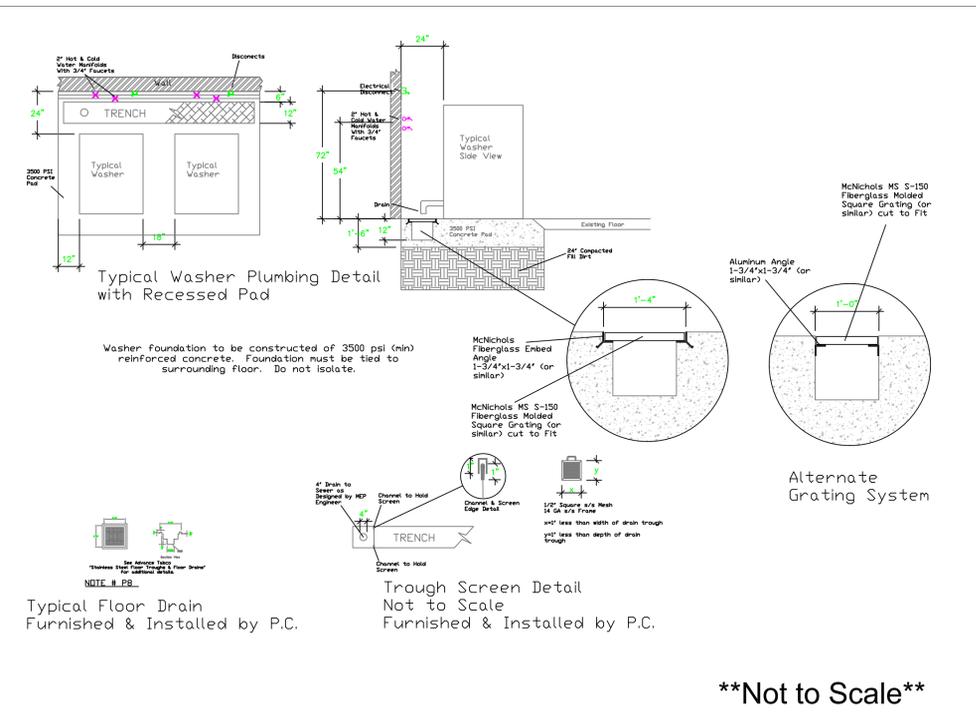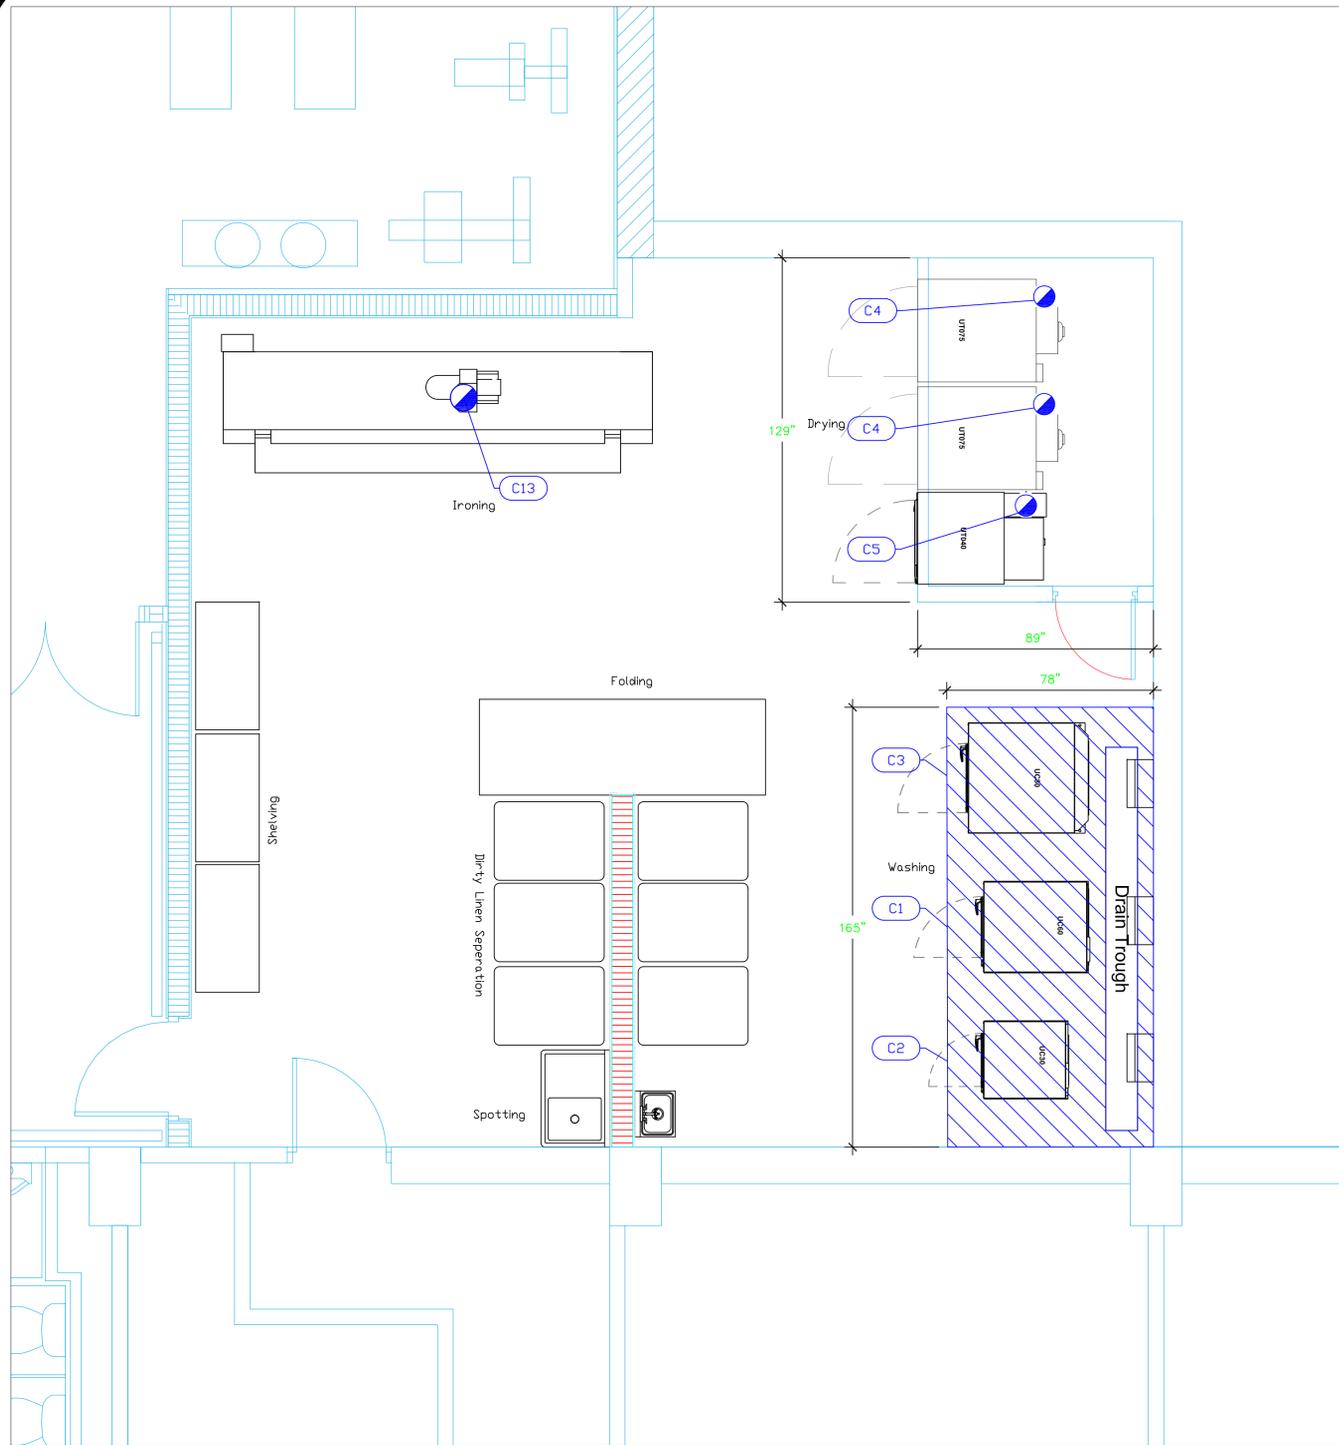

LEGEND - MECHANICAL

- EXHAUST DUCT COLLAR
- SUPPLY DUCT COLLAR
- INWALL BACKING FOR WALL SHELVES
- RECESSED FLOOR
- REINFORCED FLOOR Min.3500PSI
- RAISED EQUIPMENT PADI

NOTE # M5
ALL NATIONAL, STATE, AND LOCAL CODES SHALL APPLY

NOTE # M6
ARCHITECT OR ENGINEER TO SIZE AND LOCATE, CONTRACTOR TO PROVIDE ALL OPENINGS FOR DUCTS, PLUMBING LINES, ELECTRICAL LINES, AND REFRIGERATION LINES, AS REQUIRED BY EQUIPMENT.

NOTE # M7
SUPPLY FANS TO BE LOCATED A MINIMUM OF 10' FROM EXHAUST FANS.

NOTE # M8
SHOP DRAWING WILL BE PROVIDED BY MANUFACTURER FOR HOOD, EXHAUST FANS, & SUPPLY FANS, UNCE ORDER IS PLACE WITH.

NOTE # M9
GENERAL CONTRACTOR TO PROVIDE 2" FLYWOOD WALL BACKING FROM 48" TO 78" AFF FOR ALL WALL MOUNTED EQUIPMENT.

NOTE # M10
CEILING HEIGHTS TO BE VERIFIED FOR SUFFICIENT CLEARANCE FOR EQUIPMENT.

NOTE # M11
REFRIGERATION CONTRACTOR TO HANG EVAPORATORS FOR WALK-IN, RUN & CHARGE LINES BETWEEN EVAP. & CONDENSING UNIT.

Equipment MECHANICAL Service Requirements

All Dimensions to be verified on the job site. Actual locations for floor drains, and any ventilating equipment to be determined by Engineer. Mechanical, Plumbing & Electrical to be checked and verified by Customers MEP Engineer. Remote Condensing Units to be located by Architect. Exhaust & Supply Fans to be located by Architect.

Mechanical Schedule							
ITEM NO.	QTY	DISCRIPTION	EXHAUST (L X W)	EXHAUST (CFM)	SUPPLY (L X W)	SUPPLY (CFM)	Ventilation Remarks
1	1	Washer Extractor					Reinforced Concrete Pad
2	1	Washer Extractor					Reinforced Concrete Pad
3	1	Washer Extractor					Reinforced Concrete Pad
4	2	Drying Tumbler	8" dia	750			
5	1	Drying Tumbler	8"	650			
13	1	Flatwork Ironer	10" dia	1450			

The Brix Hotel Laundry
Trinidad & Tobago

AUTOGRAPH COLLECTION

uni-source SUPPLY
INTERNATIONAL INC.

2055 W 73rd Street, Miami, FL 33016
Ph:(305)826-8696 Fax:(305)826-9131


No.	Revision/Issue	Date
2	Changed Dryers to Electric Heat	2-21-20
3	Update based on Owner comments and site review.	3-11-20
4	Changed Ironer to Electric Heat	3-12-20
5	Added MEP information.	7-31-20

Date
July 31, 2020

Drawn By
Dayne Gauntlett


Scale
3/8" = 1'0"

Sheet
ML-2

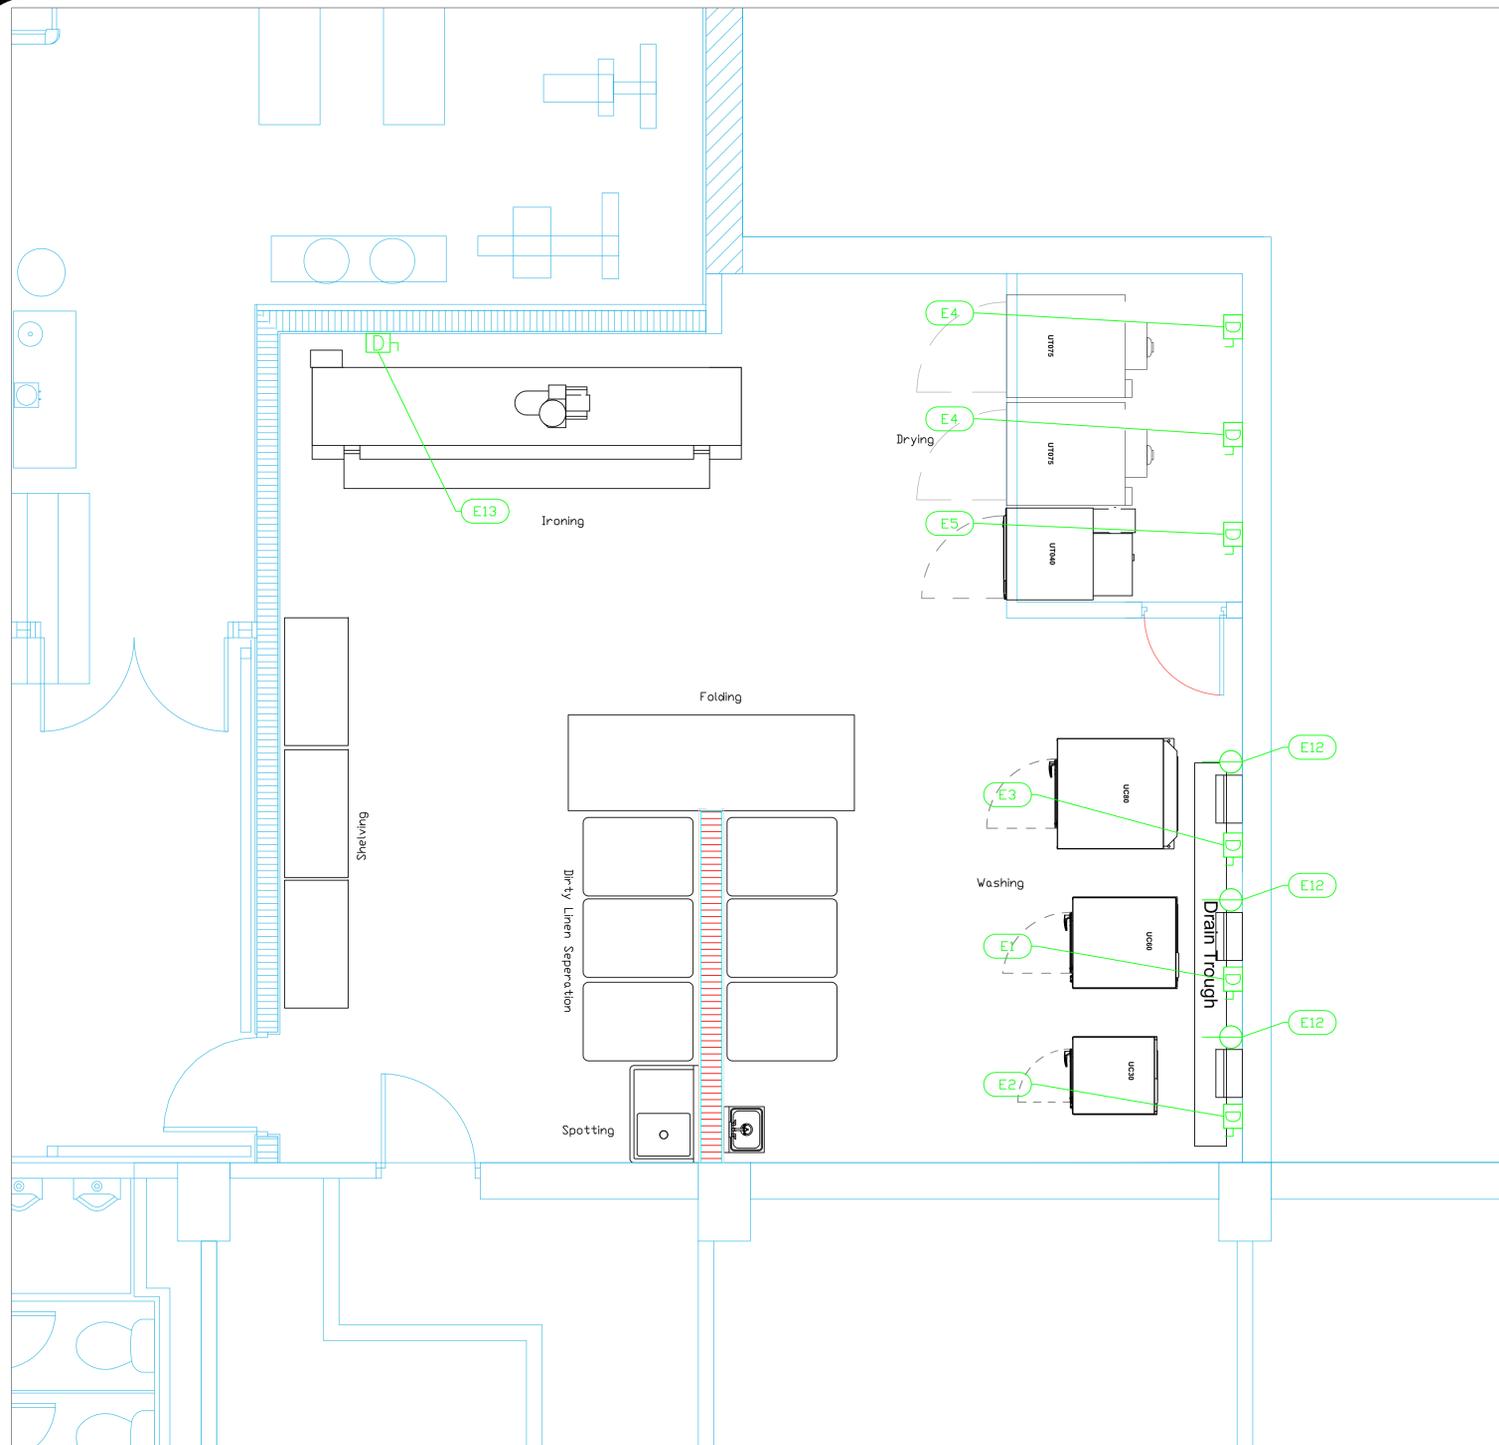

LEGEND - ELECTRICAL CONNECTIONS

- DUPLEX RECEPT., 15-AMP, 120-VOLT, GROUND TYPE, HORIZONTAL MOUNT
- SIMPLEX RECEPT., 120-VOLT, GROUND TYPE, HORIZONTAL MOUNT
- SPECIAL PURPOSE OUTLET, GROUND TYPE, HORIZONTAL MOUNT
- JUNCTION BOX, DIRECT CONNECTION
- DISCONNECT SWITCH, DIRECT CONNECTION
- FLOOR/CEILING RECEPTACLE AS INDICATED
- (2) Telephone + (2) Data
- FIELD CONNECTIONS
- HARD WIRE CONNECTION POINT AT MACHINE

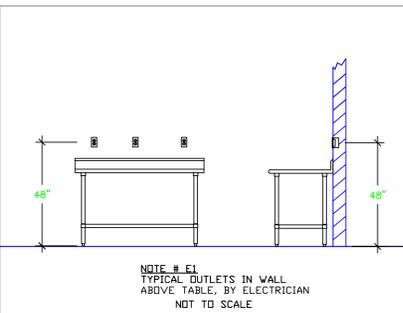

ELECTRICAL SCHEDULE										
ItemNo	Category	Voltage	Cycle	Phase	Amps	Hp	ConnectionType	Rough-In AFF	Quantity	Electrical Remarks
1	Washer Extractor	208-240	60	3	8		Disconnect	72"	1	
2	Washer Extractor	208-240	60	3	5		Disconnect	72"	1	Confirm Voltage on Existing Equipment
3	Washer Extractor	208-240	60	3	11		Disconnect	72"	1	
4	Drying Tumbler	200-208	60	3	89		Disconnect	72"	2	
5	Drying Tumbler	200-208	60	3	71		Disconnect	72"	1	Confirm Voltage on Existing Equipment
12	Chemical Pump	120	60	1	15		Simplex	36"	3	
13	Flatwork Ironer	208	60	3	81.6		Disconnect	72"	1	

NOTE # E2
ALL NATIONAL, STATE, AND LOCAL CODES SHALL APPLY

NOTE # E3
ALL ELECTRICAL CONNECTIONS AND HARDWARE REQUIRED TO BE PROVIDED BY ELECTRICAL CONTRACTOR

NOTE # E4
ALL JUNCTION BOXES, OUTLETS, ETC. TO BE LOCATED SO AS TO NOT INTERFERE WITH EQUIPMENT

NOTE # E5
ALL RELAYS, CONTRACTORS, STARTERS, AND SWITCHES REQUIRED FOR EXHAUST & SUPPLY FANS TO BE PROVIDED BY ELECTRICAL CONTRACTOR UNLESS SPECIFIED

NOTE # E6
ELECTRICAL CONTRACTOR TO INTERCONNECT DISHMACHINE TO EXHAUST FAN FOR DISHMACHINE SO THAT THE FAN RUNS WHEN THE DISHMACHINE IS IN OPERATION.

NOTE # E7
ELECTRICAL CONTRACTOR TO INSTALL TABLE LIMIT SWITCH TO END OF CLEAN DISHTABLE TO THAT MACHINE STOPS WHEN SWITCH IS DEPRESSED.

NOTE # E8
ELECTRICAL CONTRACTOR TO CONNECT DRAIN LINE HEATER, PAN HEATER AND DODR HEATER FOR WALK-IN FREEZER.

Equipment ELECTRICAL Service Requirements

All Dimensions to be verified on the job site. Actual locations for floor drains, and any ventilating equipment to be determined by Engineer. Mechanical, Plumbing & Electrical to be checked and verified by Customers MEP Engineer. Remote Condensing Units to be located by Architect. Exhaust & Supply fans to be located by Architect.

The Brix Hotel
Laundry
Trinidad & Tobago

AUTOGRAPH
COLLECTION™






INTERNATIONAL INC.

2055 W 73rd Street, Miami, FL 33016
Ph:(305)826-8696 Fax:(305)826-9131


No.	Revision/Issue	Date
2	Changed Dryers to Electric Heat	2-21-20
3	Update based on Owner comments and site review.	3-11-20
4	Changed Ironer to Electric Heat.	3-12-20
5	Added MEP information.	7-31-20

Date
July 31, 2020
Drawn By
Dayne Gauntlett
Scale
3/8" = 1'0"

Sheet
ML-3

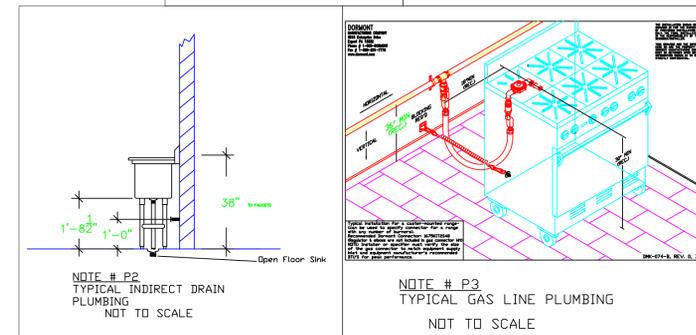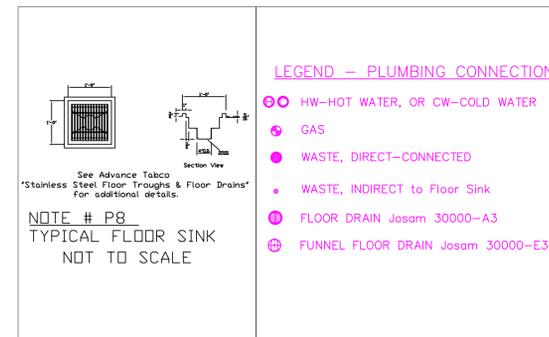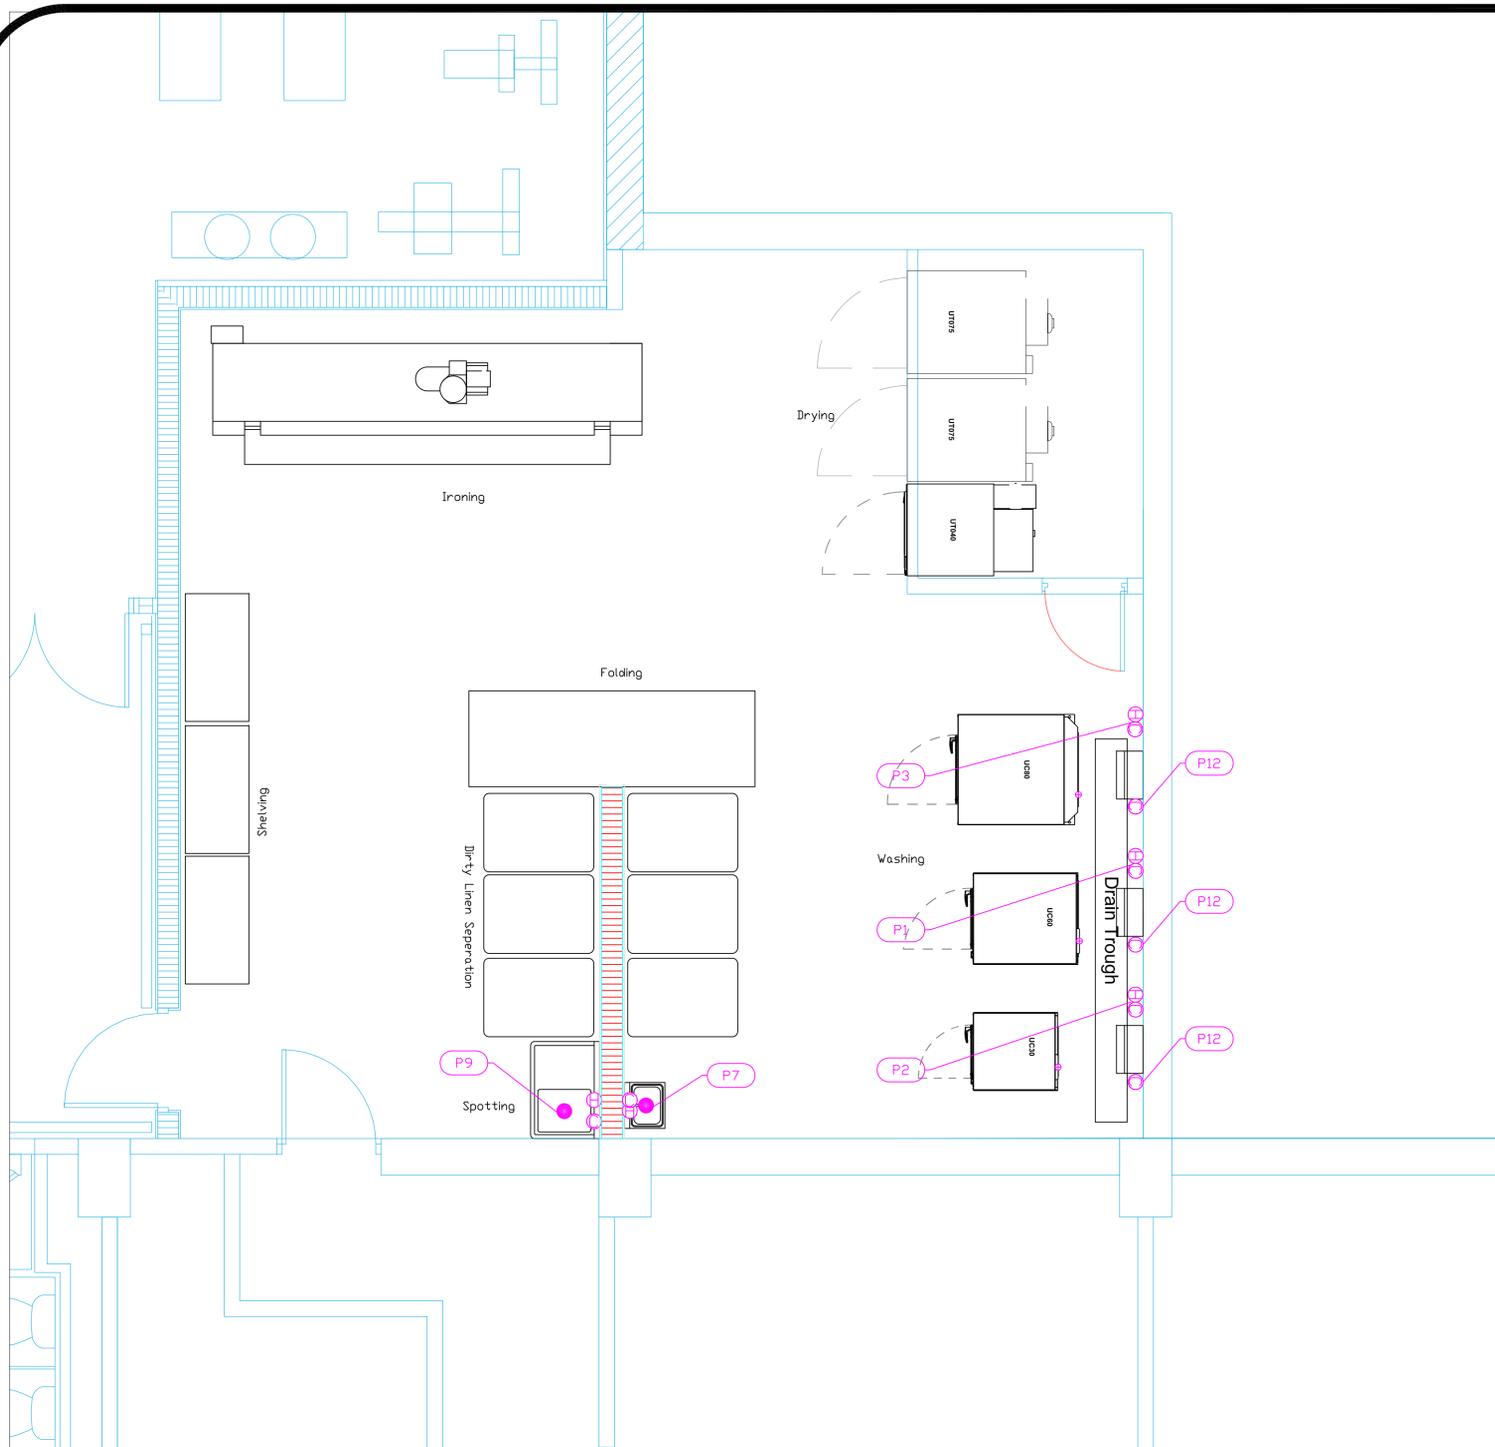

PLUMBING SCHEDULE												
ITEM NO.	DESCRIPTION	COLD WATER SIZE	HOT WATER SIZE	H&C ROUGH-IN	DIRECT WASTE SIZE	DIRECT WASTE AFF	INDIRECT WASTE SIZE	GAS SIZE(IN)	GAS CONN. AFF	GAS MBTU	QTY	PLUMBING REMARKS
1	Washer Extractor	3/4"	3/4"	54"			3"				1	
2	Washer Extractor	3/4"	3/4"	54"			2"				1	
3	Washer Extractor	3/4"	3/4"	54"			3"				1	
7	Hand Sink	1/2"	1/2"	12"	1-1/2"	24"					1	See Note P1
9	One (1) Compartment Sink				1-1/2"	24"					1	(1) set of 1/2" faucet holes, 8" OC
	Wall / Splash Mount Faucet	1/2"	1/2"	12"							1	
12	Chemical Pump	5/8"		24"							3	Garden Hose Bib

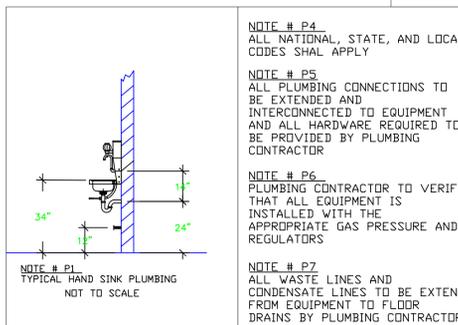

NOTE # P4
ALL NATIONAL, STATE, AND LOCAL CODES SHALL APPLY

NOTE # P5
ALL PLUMBING CONNECTIONS TO BE EXTENDED AND INTERCONNECTED TO EQUIPMENT AND ALL HARDWARE REQUIRED TO BE PROVIDED BY PLUMBING CONTRACTOR

NOTE # P6
PLUMBING CONTRACTOR TO VERIFY THAT ALL EQUIPMENT IS INSTALLED WITH THE APPROPRIATE GAS PRESSURE AND REGULATORS

NOTE # P7
ALL WASTE LINES AND CONDENSATE LINES TO BE EXTEND FROM EQUIPMENT TO FLOOR DRAINS BY PLUMBING CONTRACTOR.

Equipment PLUMBING Service Requirements

All Dimensions to be verified on the job site. Actual locations for floor drains, and any ventilating equipment to be determined by Engineer. Mechanical, Plumbing & Electrical to be checked and verified by Customers MEP Engineer. Remote Condensing Units to be located by Architect. Exhaust & Supply fans to be located by Architect.

The Brix Hotel
Laundry
Trinidad & Tobago

AUTOGRAPH
COLLECTION™

uni-source
SUPPLY
INTERNATIONAL INC.

2055 W 73rd Street, Miami, FL 33016
Ph:(305)826-8696 Fax:(305)826-9131

No.	Revision/Issue	Date
2	Changed Dryers to Electric Heat	2-21-20
3	Update based on Owner comments and site review.	3-11-20
4	Changed Ironer to Electric Heat.	3-12-20
5	Added MEP information.	7-31-20

Date
July 31, 2020

Drawn By
Dayne Gauntlett

Scale
3/8" = 1'0"

Sheet
ML-4